RIVERWALK

STAGE 40 GEELONG ROAD, WERRIBEE WYNDHAM CITY COUNCIL

FOR



CIVIL DRAWINGS ROADS AND DRAINAGE

DCE REF: 10940 MELWAY REF: 205 G10

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- 1. ALL LEVELS ARE TO AUSTRALIAN HEIGHT DATUM AND ALL COORDINATES ARE TO MAP GRID OF AUSTRALIA (MGA) ZONE 55.
- 2. ALL WORKS TO BE CARRIED OUT IN ACCORDANCE WITH AS2124 9 (AMENDED) GENERAL CONDITIONS OF CONTRACT, THE ROAD & DRAINAGE SPECIFICATION, APPROVED VPA (EDCM) & COUNCIL SPECIFICATION AND STANDARD DRAWINGS, AND TO THE SATISFACTION OF THE SUPERINTENDENT AND THE CITY ENGINEER OR HIS REPRESENTATIVE.
- 3. A PRE-COMMENCEMENT MEETING WITH COUNCIL IS TO BE ARRANGED PRIOR TO COMMENCEMENT OF THE WORKS.
- 4. ALL SERVICE AUTHORITIES SHALL BE NOTIFIED IN WRITING SEVEN DAYS PRIOR TO COMMENCEMENT OF THE WORKS.
- 5. TBMS TO BE RE-ESTABLISHED BY THE LICENSED SURVEYOR IF FOUND TO BE MISSING AT THE COMMENCEMENT OF CONSTRUCTION. THE CONTRACTOR WILL BE RESPONSIBLE FOR CARE AND MAINTENANCE OF TBMS THEREAFTER.
- 6. ALL EXISTING SURFACE LEVELS SHOWN ON THE ENGINEERING DRAWINGS HAVE BEEN INTERPOLATED FROM A DIGITAL TERRAIN MODEL. THESE LEVELS HAVE BEEN USED AS THE BASIS FOR ALL ENGINEERING DESIGN AND DETERMINATION OF QUANTITIES.
- 7. THE CONTRACTOR SHALL ENSURE THAT WORKS WITHIN ROADWAYS ARE TO CONFORM TO THE 'CODE OF PRACTICE FOR WORKSITE SAFETY - TRAFFIC MANAGEMENT (2010)' UNDER THE ROAD MANAGEMENT ACT 2004 AND THE ROAD SAFETY ACT 1986. THE CONTRACTOR SHALL ALSO ENSURE THAT WORKS ARE TO THE APPROVAL OF THE COORDINATING ROAD AUTHORITY UNDER THE ROAD MANAGEMENT ACT 2004.
- PREPARATION OF THE TRAFFIC MANAGEMENT PLAN AND ITS IMPLEMENTATION UNDER A TRAFFIC GUIDANCE SCHEME SHALL ONLY BE UNDERTAKEN BY A CONTRACTOR OR SUBCONTRACTOR SUITABLY PREQUALIFIED WITH VICROADS.
- THE CONTRACTOR IS RESPONSIBLE FOR GAINING APPROVAL OF THE TRAFFIC MANAGEMENT PLAN FROM VICROADS/COUNCIL AT LEAST 7 DAYS PRIOR TO WORKS COMMENCING OR EARLIER IF REQUIRED.
- THE TRAFFIC MANAGEMENT PLAN AND TRAFFIC GUIDANCE SCHEME (INCLUDING ANY ACCESS REQUIREMENTS) SHALL BE APPROVED BY THE COORDINATING ROAD AUTHORITY APPROPRIATE TO THE PROJECT IN ACCORDANCE WITH SECTION 36 OF THE ROAD MANAGEMENT ACT 2004.
- THE CONTRACTOR IS REQUIRED TO CONFINE CONSTRUCTION VEHICLES TO THE ROAD RESERVE AND EASEMENTS. ANY DAMAGE CAUSED TO ALLOTMENTS MUST BE MADE GOOD.
- 10. ANY BUILDINGS, TROUGHS, FENCES AND OTHER STRUCTURES ON SITE ARE TO BE REMOVED AS DIRECTED BY THE ENGINEER. THE COST OF REMOVAL IS TO BE INCLUDED IN THE OVERALL EARTHWORKS FIGURE UNLESS A SPECIFIC ITEM FOR REMOVAL IS DENOTED IN THE SCHEDULE.
- 11. FILL AREAS IN EXCESS OF 300mm ARE TO BE STRIPPED OF TOPSOIL, FILLED, AND TOPSOIL REPLACED TO OBTAIN THE FINAL FILL LEVELS SHOWN ON THE DRAWINGS. ALL FILLING MUST ENSURE LEVEL 1 GEOTECHNICAL SUPERVISION IS MAINTAINED AS PER CLAUSE 8.2 OF AS3798 "GUIDELINES ON EARTHWORKS FOR COMMERCIAL AND RESIDENTIAL DEVELOPMENTS". STRUCTURAL FILLING MATERIAL IS TO BE APPROVED BY THE SUPERINTENDENT AND COUNCIL PRIOR TO PLACEMENT.
- 12. NO FILL OR STOCKPILING OF MATERIAL IS TO BE PLACED ON ANY RESERVE OR COMMON PROPERTY UNLESS OTHERWISE DIRECTED BY THE ENGINEER. NO TOPSOIL IS TO BE REMOVED FROM SITE. SURPLUS SOIL MUST BE MADE AVAILABLE FOR LOTS AND RESERVES.
- 13. WHERE PAVEMENT IS CONSTRUCTED ON FILLING, FILL MATERIAL IS TO BE APPROVED BY THE SUPERINTENDENT AND COUNCIL AND CONSTRUCTED IN LAYERS 150MM THICK WITH COMPACTION IN ACCORDANCE WITH AS3798. PRIOR TO THE PLACEMENT OF THE FILL MATERIAL UNDER NEW PAVEMENTS, APPROVAL OF THE MATERIAL TO BE USED MUST BE OBTAINED FROM COUNCIL.
- 14. WHEN PAVEMENT EXCAVATION IS IN ROCK ALL LOOSE MATERIAL (INCLUDING ROCKS AND CLAY) MUST BE REMOVED. THE SUB-GRADE MUST THEN BE REGULATED WITH COUNCIL APPROVED MATERIAL.
- 15. AT LEAST 3 DAYS BEFORE COMMENCING EXCAVATION OF TRENCHES IN EXCESS OF 1.5m DEPTH, A COMPLETED "NOTICE OF INTENTION TO COMMENCE TRENCHING OPERATIONS" FORM SHALL BE SENT TO WORKSAFE VICTORIA. THE NOMINATED SUPERVISOR SHALL BE SUITABLY QUALIFIED IN ACCORDANCE WITH VICTORIAN OHS ACT 1985 & COMMONWEALTH OHS CODE OF PRACTICE 2008.
- 16. NO BLASTING TO BE PERMITTED.
- 17. ALL TREES AND SHRUBS ARE TO BE RETAINED UNLESS OTHERWISE SHOWN, IF ROAD AND DRAINAGE CONSTRUCTION NECESSITATES THEIR REMOVAL, WRITTEN PERMISSION MUST BE OBTAINED FROM THE ENGINEER.
- 18. ALL DISTURBED SURFACES SHOULD BE OVER EXCAVATED BY 150mm, TOP SOILED WITH MINIMUM 150mm OF LOCAL TOP SOIL AND BITUMEN STRAW HYDROSEEDED.
- 19. ALL TOPSOIL TO BE 100mm (MIN) DEPTH. BE FREE OF CLAY. STONES, LOGS, WEED AND OTHER PERISHABLE MATERIAL WHICH IS NOT SUITABLE FOR PLANTING OF LAWNS IN ACCORDANCE WITH VPA AND WCC GUIDELINES.
- 20. ALL BLOCKS ARE TO SURFACE GRADE WITH A MINIMUM FALL OF 1 IN 150 ALONG THE LOW SIDE BOUNDARY TO THE POINT OF DISCHARGE.
- 21. ALL BATTERS SHALL BE 1 IN 6, UNLESS OTHERWISE SHOWN.
- 22. ALL CHAINAGES REFER TO ROAD RESERVE CENTRELINES EXCEPT: - IN COURT HEADS WHERE CHAINAGES REFER TO LIP OF KERB - KERB RETURNS WHERE CHAINAGES REFER TO LIP OF KERB.
- 23. GENERALLY 600B2 KERB AND CHANNEL IS TO BE USED THROUGHOUT THE SUBDIVISION. WHERE OTHER KERB TYPES ARE REQUIRED THEY ARE SPECIFICALLY SHOWN ON THE DRAWINGS. ALL KERB PROFILES IN ACCORDANCE WITH EDCM 301.
- 24. LIP OF ALL KERB RADII ARE 8.60m UNLESS OTHERWISE SHOWN.
- 25. FOOTPATHS TO BE OFFSET 50mm FROM THE TITLE BOUNDARIES.
- 26. ALL FOOTPATHS TO BE IN ACCORDANCE WITH EDCM STANDARD DRAWING 401, 402 AND
- 27. VEHICULAR CROSSINGS OF THE TYPE INDICATED ARE TO BE OFFSET FROM THE LOT BOUNDARY OR EASEMENT IN ACCORDANCE WITH EDCM 501, 502 OR 503. UNLESS OTHERWISE SHOWN.

- 28. PROVIDE LAYBACKS IN KERB TO ALL PRAM CROSSINGS IN ACCORDANCE WITH EDCM 403. ASPHALT FILLETS/RAMPS ARE TO BE PROVIDED ON THE BASE COURSE ASPHALT TO REMOVE TRIPS AT ALL PEDESTRIAN CROSSING LOCATIONS.
- 29. ALL LINE MARKING AND SIGNAGE TO BE INSTALLED IN ACCORDANCE WITH AS 1742-1 AND AS 1742-2, UNLESS SPECIFICALLY SHOWN OTHERWISE. LINEMARKING IS TO BE INSTALLED USING EXTRUDED LONG LIFE THERMOPLASTIC PAINT. TEMPORARY LINEMARKING USING ORDINARY PAINT IS TO BE APPLIED WHEN WEARING COURSE ASPHALT IS NOT APPLIED FOR A PERIOD OF TIME E.G. AT PRACTICAL COMPLETION. STREET SIGNS ARE REQUIRED TO SHOW STREET NUMBERS APPLICABLE TO EACH BLOCK. ALL TEMPORARY WARNING SIGNS USED DURING CONSTRUCTION SHALL BE IN ACCORDANCE WITH AS 1742-3.
- 30. THE LOCATION OF EXISTING SERVICES SHOWN ON THESE PLANS SHALL BE PROVEN ON SITE. THE APPROPRIATE AUTHORITY SHALL BE CONTACTED AND THE SERVICES LOCATED PRIOR TO COMMENCEMENT OF CONSTRUCTION.
- 31. ALL EASEMENTS ARE 2.5m OR 3.0m WIDE DRAINAGE AND SEWERAGE EASEMENTS UNLESS OTHERWISE SHOWN.
- 32. CENTRELINES OF ALL SEWERS WITHIN EASEMENTS ARE OFFSET FROM THE PROPERTY LINE IN ACCORDANCE WITH CURRENT MRWA VERSION WSA 02.2014. UNLESS OTHERWISE SHOWN.
- 33. CENTRELINES OF ALL EASEMENT DRAINS ARE OFFSET 1.0m OR 2.2m FROM THE PROPERTY LINE UNLESS OTHERWISE SHOWN.
- 34. ALL STORMWATER DRAINS ARE TO BE CLASS '2' RC OR FRC PIPES UNLESS OTHERWISE SHOWN. ALL RC PIPES UP TO AND INCLUDING 750mm DIA. ARE TO BE RUBBER RING JOINTED, INTERLOCKING / FLUSH JOINTS WITH EXTERNAL BANDS CAN BE USED ON PIPES OVER 750mm DIA.
- 35. WHERE CURVED PIPES ARE SHOWN ON THE FACE PLANS THEY ARE TO BE LAID PARALLEL TO THE BACK OF KERB, EXCEPT WHERE A RADIUS HAS BEEN SPECIFICALLY NOMINATED. ALL DRAINS BEHIND KERBS ARE TO BE LAID AT THE OFFSET SPECIFIED IN THE COUNCIL SPECIFICATION. CURVED PIPES OF DIAMETER LESS THAN 600mm ON LARGE RADIUS CURVES ARE APPROVED BY COUNCIL SUBJECT TO COMPLIANCE WITH MANUFACTURER'S SPECIFICATION.
- 36. ALL PIPE AND SERVICE TRENCHES THAT EXTEND UNDER ROADWAYS TO BE BACKFILLED WITH CLASS 2 CRUSHED ROCK. ALL SERVICE TRENCHES UNDER DRIVEWAYS, FOOTPATHS AND PARKING BAYS TO BE BACKFILLED WITH CLASS 2 CRUSHED ROCK. SERVICE TRENCHES LESS THAN 750mm BEHIND
- 37. A.G. DRAIN TO BE LAID UNDER ALL KERB & CHANNEL AT THE DEEPER OF 750mm BELOW KERB OR TO THE BOTTOM OF THE SUBBASE LAYER, IN ACCORDANCE WITH EDCM STANDARD DRAWING 202 AND GEOTECHNICAL REPORT G418.AB DATE 29/08/17 PROVIDED BY GROUND SCIENCE.

PARKING BAYS ARE ALSO TO BE BACKFILLED WITH COMPACTED CLASS 2 CRUSHED ROCK.


- 38. PROPERTY INLETS ARE TO PLACED 1.0m FROM LOW CORNERS OF ALLOTMENTS UNLESS OTHERWISE SHOWN. ALL INLETS TO BE IN ACCORDANCE WITH EDCM 701, 702, 703 AND
- 39. 100mm DIA. HOUSE DRAINS IN STREETS TO BE PLACED 6.0m FROM LOW CORNERS UNLESS OTHERWISE SHOWN.
- 40. POSITION CONDUITS SO THAT A MINIMUM DISTANCE BETWEEN TAPPINGS IS 1.0m. CONDUITS NOT TO BE LOCATED WITHIN 4.0m OF ALLOTMENT BOUNDARY, UNLESS OTHERWISE SHOWN.
- 41. WATER TAPPINGS FOR LOTS SITUATED ON THE SAME SIDE AS THE WATERMAIN ARE TO BE LOCATED AT THE CENTRE OF THE LOT UNLESS OTHERWISE SHOWN. THE KERB IS TO BE MARKED "W" WITH AN ARROW POINTING TO THE TAPPING.
- 42. GAS TO BE 50mm DIA. CLASS 12 P.V.C. & WATER CONDUITS TO BE 100 DIA. CLASS 12 P.V.C. SINGLE CONDUIT CONTAINING BOTH DW & NDW SERVICES LAID IN ACCORDANCE WITH WSA 03-2002 DUAL WATER SUPPLY SYSTEM STANDARD DRAWING WAT-1806-V
- 43. ELECTRICITY CONDUITS ARE TO BE LAID IN ACCORDANCE WITH AUTHORITY REQUIREMENTS

SP AUSNET (GAS)

- 44. GAS MAINS, FITTINGS AND MARKER TAPE ARE TO BE SUPPLIED BY TXU (GAS).
- 45. EXCAVATION, SUPPLY AND PLACEMENT OF REQUIRED BACKFILL TO BE BY OTHERS.
- 46. TWO WEEKS OF NOTIFICATION OF COMMENCEMENT OF EXCAVATION WORKS SHALL BE GIVEN TO THE DISTRICT CENTRE.
- 47. THE CONTRACTOR SHOULD QUOTE PROJECT NO. 74267234 TO ENABLE MAIN LAYING TO BE COORDINATED WITH OTHER SERVICES.

REINFORCED CONCRETE PIPE

- 48. ALL STORMWATER DRAINAGE PIPES SHALL NOT BE SUBJECTED TO CONSTRUCTION TRAFFIC LOADING DURING CONSTRUCTION UNLESS THE PIPE STRENGTH CHARACTERISTICS HAVE BEEN COMPUTED AND APPROVED BY THE CONTRACTORS ENGINEER. COMPUTATIONS ARE TO ACCORD WITH AS.3725-2007, LOADS ON BURIED PIPES.
- 49. CONCRETE PIPES DAMAGED DUE TO CONSTRUCTION LOADS SHALL BE REPLACED & RELAID AT CONTRACTOR'S COST.
- 50. ALL PIPES TO BE CLASS '2' R.C. OR F.R.C RUBBER RING JOINT UNLESS NOTED OTHERWISE. PIPES GREATER THAN 750mm DIA MAY BE FLUSH JOINTED WITH EXTERNAL

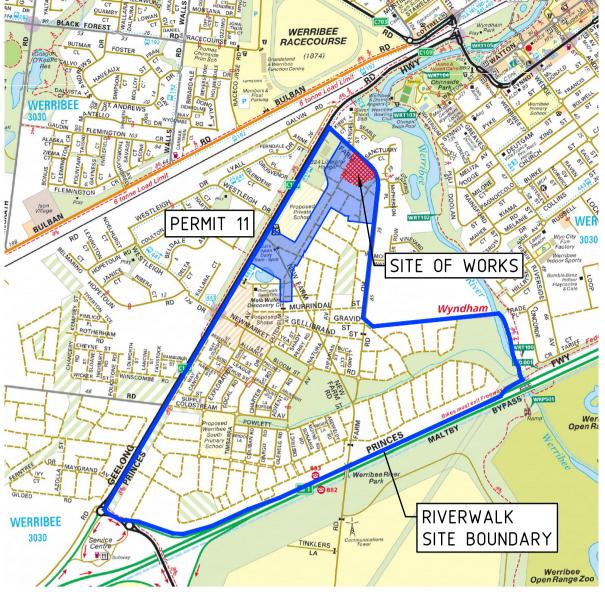

LOCALITY PLAN MELWAYS: 205 G10 SCALE @ A1:

DRAWING INDEX

| SHEET No. | DRAWING No. | DESCRIPTION |
|-----------|--------------|---|
| 01 | 10940TD01 | NOTES, LOCALITY PLAN AND DRAWING INDEX |
| 02 | 10940TD02 | TYPICAL DETAILS AND PAVEMENT DETAILS |
| 03 | 10940TD03 | TYPICAL SECTIONS |
| 04 | 10940SP01 | STAGING PLAN |
| 05-06 | 10940DP01-02 | DETAIL PLAN, SHEETS 01 TO 02 |
| 07-11 | 10940ID01-05 | INTERSECTION DETAILS, SHEETS 01 TO 05 |
| 12 | 10940LM01 | SIGNAGE AND LINEMARKING PLAN |
| 13–16 | 10940LS01-04 | ROAD LONGITUDINAL SECTIONS, SHEETS 01 TO 04 |
| 17-18 | 10940FD01-02 | FOOTPATH DETAILS. SHEETS 02 TO 02 |
| 19 | 10940LD01 | LANEWAY CONCRETE PAVEMENT DETAILS |
| 20-29 | 10940XS01-10 | CROSS SECTIONS, SHEETS 01 TO 10 |
| 30-32 | 10940DR01-03 | DRAINAGE LONGITUDINAL SECTIONS, SHEETS 01 TO 03 |
| 33 | 10940PIT01 | PIT SCHEDULE |
| 34-35 | 10940FP01-02 | FILL PLAN, SHEETS 01 TO 02 |
| 36 | 10940CON01 | RESERVE CONTOUR AND TREE PLAN |
| 37-38 | 10940EW01-02 | EARTHWORKS PLAN, SHEETS 01 TO 02 |
| 39-40 | 10940EF01-02 | EXISTING FEATURES PLAN, SHEETS 01 TO 02 |

CAUTION!

ALL EXISTING SERVICES IN THE VICINITY OF WORKS SHALL BE PROTECTED AND KEPT IN FUNCTIONAL STATE AT ALL TIMES DURING WORKS.

BEWARE!

NBN OPTIC FIBRE CABLES IN THE VICINITY OF WORKS. TEL: 1800 687 626.

BEWARE!

TELSTRA OPTIC FIBRE CABLES IN THE VICINITY OF WORKS. TEL: 9253 8263.

BEWARE!

TELSTRA MAJOR CABLES ARE IN THE VICINITY OF WORKS.

BEWARE!

DEVELOPMENT VICTORIA FTTH OPTIC FIBRE CABLES IN THE VICINITY OF WORKS. TEL: 03 9311 4575**.**

WARNING!

NO DRAINAGE WORKS SHALL COMMENCE UNTIL THE CONTRACTOR CONFIRMS THE I.L. OF ALL EXISTING DRAINS, AND CONFIRMS IN WRITING WITH THE ENGINEERING SUPERVISOR.

DANGER!


OVERHEAD ELECTRICITY TRANSMISSION LINES. CONTRACTOR TO EXERCISE EXTREME CAUTION WHEN OPERATING IN THE VICINITY OF THESE LINES. THE CONTRACTOR MUST ADHERE TO ALL "NO GO ZONE" REQUIREMENTS OF THE POWER AUTHORITY.

WARNING!

THE LOCATION OF EXISTING SERVICES SHOWN ON THESE PLANS MUST BE PROVEN ON SITE. THE APPROPRIATE AUTHORITY MUST BE CONTACTED AND THE SERVICES LOCATED PRIOR TO COMMENCEMENT OF ANY WORKS.

WARNING!

BEWARE OF ASBESTOS! SOME UNDERGROUND SERVICES MAY BE CONSTRUCTED FROM ASBESTOS CONTAINING MATERIAL. CONTACT THE SUPERINTENDENT FOR INSTRUCTIONS ON HOW TO MANAGE ANY POTENTIAL ASBESTOS HAZARD.

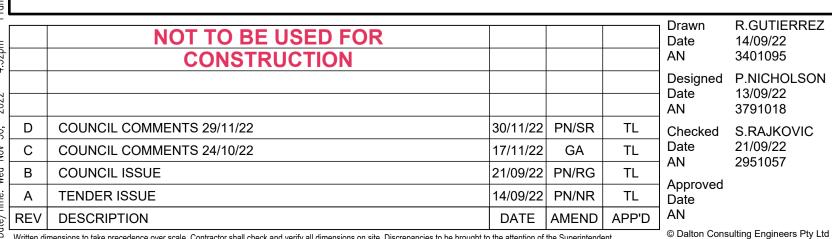

Written dimensions to take precedence over scale. Contractor shall check and verify all dimensions on site. Discrepancies to be brought to the attention of the Superintendent.

R.GUTIERREZ 14/09/22 3401095 Designed P.NICHOLSON 13/09/22 3791018 Checked S.RAJKOVIC 21/09/22 2951057 Approved





Scale @ A1/A3

RIVERWALK STAGE 40 **GEELONG ROAD, WERRIBEE** WYNDHAM CITY COUNCIL NOTES, LOCALITY PLAN **AND DRAWING INDEX** Drawing No. 10940TD01 Sheet No. 01 of 40 As Shown




Rev D

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PAVEMENT DETAILS

| ACCESS STREE | Γ 1 | | | | | |
|--|--|--|--|--|--|--|
| GRAMPIANS AVENUE, KAILASH ROAD, SORTIE STREE HANGER STREET, BATCHELOR STREET | | | | | | |
| ASPHALT | WEARING COURSE 30mm SIZE 10mm TYPE N (C320 BINDER) BASE 30mm SIZE 10mm TYPE N (C320 BINDER) PRIMER SEAL AND SAMI 10mm (S 18RF) | | | | | |
| LAYER A | BASE 130mm VICROADS CLASS 2 FCR (20mm) COMPACTED TO A MINIMUM DENSITY RATIO OF 98% (MODIFIED) AS1289; 5.2.1 | | | | | |
| LAYER B | UPPER SUBBASE 120mm VICROADS CLASS 3 FCR (20mm) COMPACTED TO A MINIMUM DENSITY RATIO OF 98% (MODIFIED) AS1289; 5.2.1 LOWER SUBBASE 100mm VICROADS CLASS 4 FCR (20mm) COMPACTED TO A MINIMUM DENSITY RATIO OF 98% (MODIFIED) AS1289; 5.2.1 CAPPING 150mm THICK VICROADS TYPE A CAPPING LAYER AS PER GROUND SCIENCE 4787.1 AA TABLE 4. CAPPING MATERIAL WITH CBR ≥ 8.0% MIN, SWELL ≤1.5% AND PERMEABILITY ≤5×10 ⁽⁻⁹⁾ m/sec. COMPACTED TO A MINIMUM DENSITY RATIO OF 98% (STANDARD AS1289: 5.1.1) | | | | | |
| DEPTH TOTAL | 570mm min. | | | | | |
| CONSTRUCTION LAYER | CONSTRUCTION LAYER 150mm THICK VICROADS TYPE A CAPPING LAYER AS PER GROUND SCIENCE 4787.1 AA TABLE 4. CBR ≥ 8%, SWELL ≤ 1.5%, PERMEABLITY K ≤ 5×10 ⁻⁹ %. COMPACTED TO A MINIMUM DRY DENSITY RATIO OF 98% (STANDARD AS1289;5.1.1) ±3% of OMC | | | | | |
| SUBGRADE | SUBGRADE UNIT 4 OR 5 NATURAL SOIL OR CLAY CONTROLLED FILL (CBR ≥ 2.0%) | | | | | |

- REFER GROUND SCIENCE G4797.1 AA DATED: 10/08/2022 - CONTRACTOR TO ENSURE NEAT TRANSITION BETWEEN ADJOINING PAVEMENTS FROM PREVIOUS STAGES

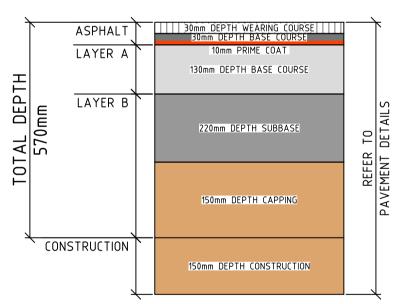

TYPICAL PAVEMENT DETAIL SCALE @ A1 1:10


R.GUTIERREZ 14/09/22


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21/09/22

2951057

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NOT TO BE USED FOR CONSTRUCTION Designed P.NICHOLSON
Date 13/09/22
AN 3791018 D COUNCIL COMMENTS 29/11/22 30/11/22 PN/SR TL Checked S.RAJKOVIC Date C COUNCIL COMMENTS 24/10/22 17/11/22 GA B COUNCIL ISSUE 21/09/22 PN/RG TL 14/09/22 PN/NR TL Date ġ│ A │ TENDER ISSUE DATE AMEND APP'D AN REV DESCRIPTION

Written dimensions to take precedence over scale. Contractor shall check and verify all dimensions on site. Discrepancies to be brought to the attention of the Superintendent.

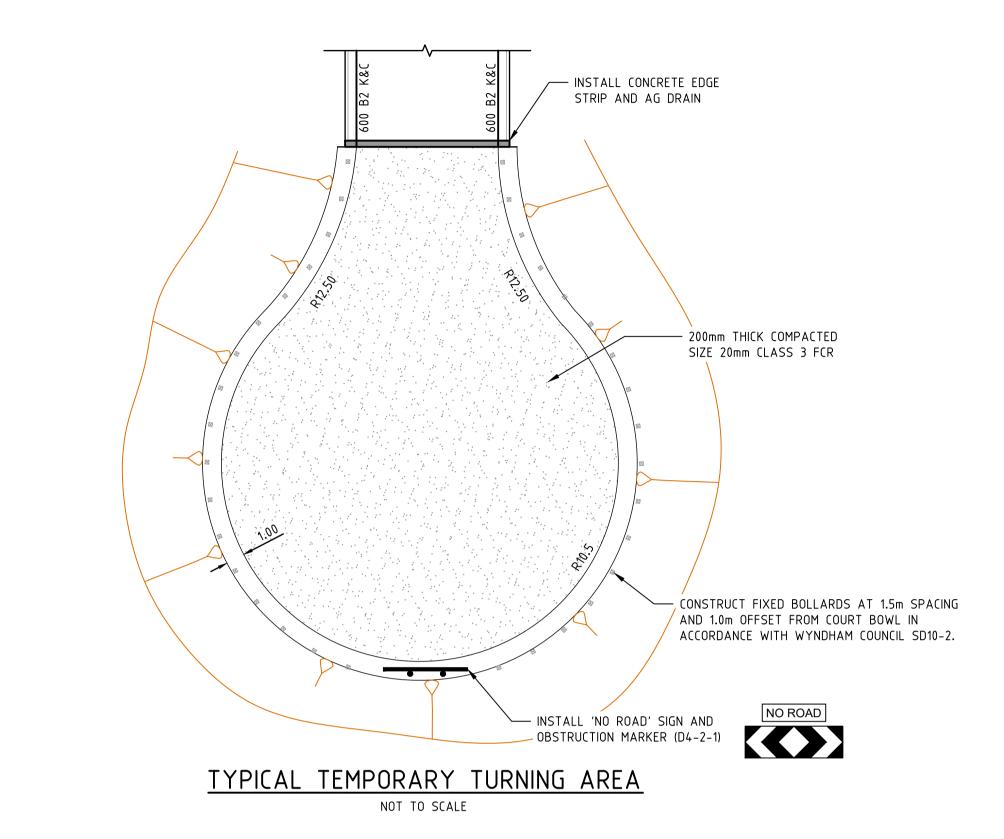

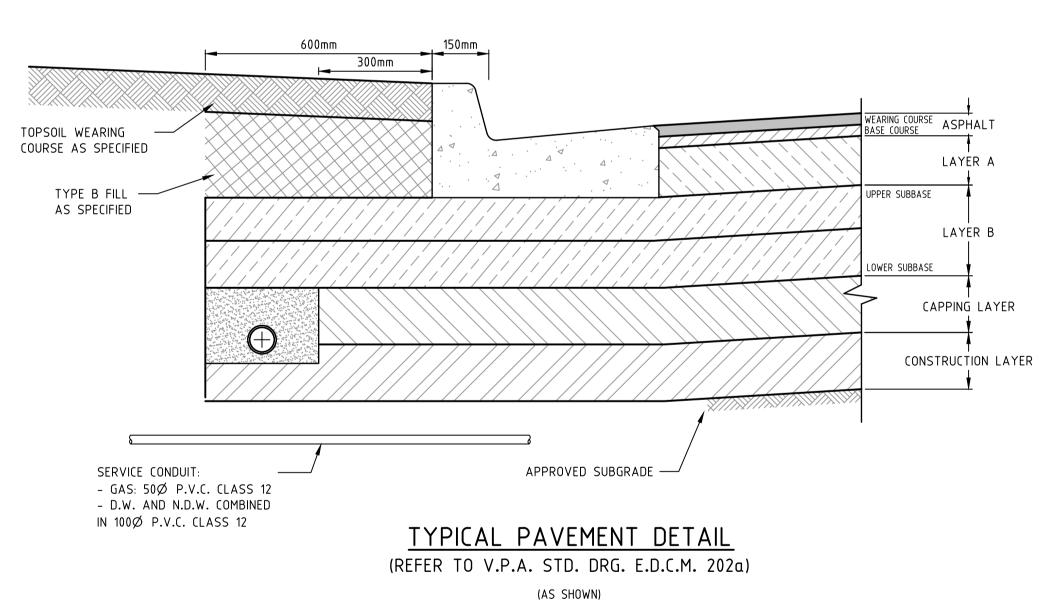
RIVERWALK STAGE 40 GEELONG ROAD, WERRIBEE WYNDHAM CITY COUNCIL TYPICAL DETAILS AND **PAVEMENT DETAILS** Drawing No. 10940TD02 Rev D

Sheet No. 02 of 40



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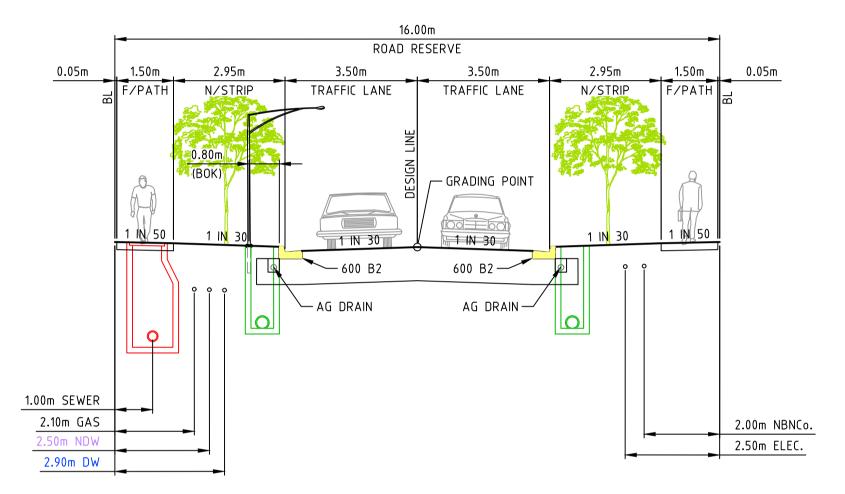
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STANDARD ACCESS STREET (16m)

GRAMPIANS AVENUE SCALE 1:100

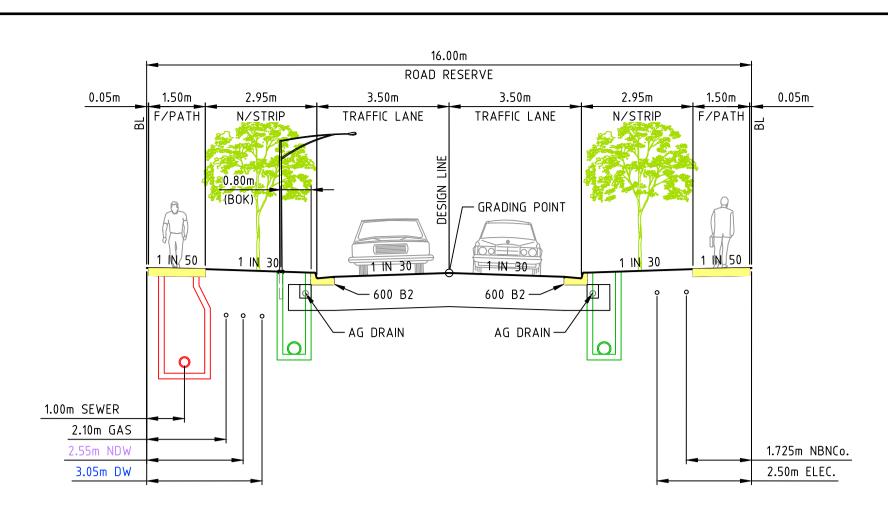
SEWER AND DRAINAGE SHOWN INDICATIVELY; REFER TO DETAIL PLAN FOR ACTUAL LOCATION




STANDARD ACCESS STREET (16m)

BATCHELOR STREET (LOTS 4019 TO 4024) SCALE 1:100 SEWER AND DRAINAGE SHOWN INDICATIVELY;


REFER TO DETAIL PLAN FOR ACTUAL LOCATION

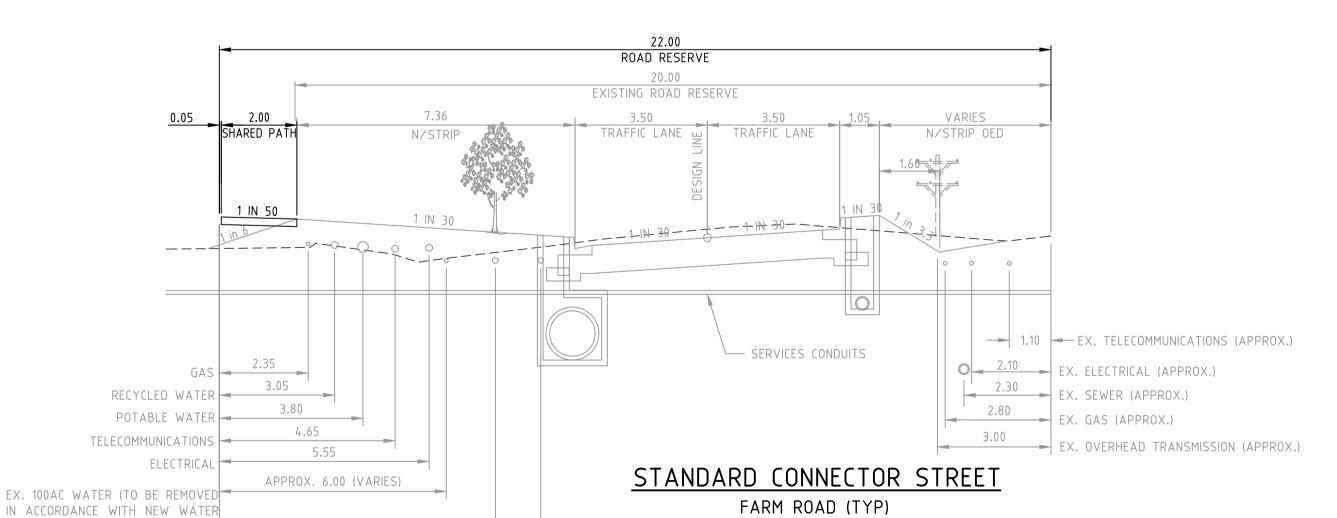

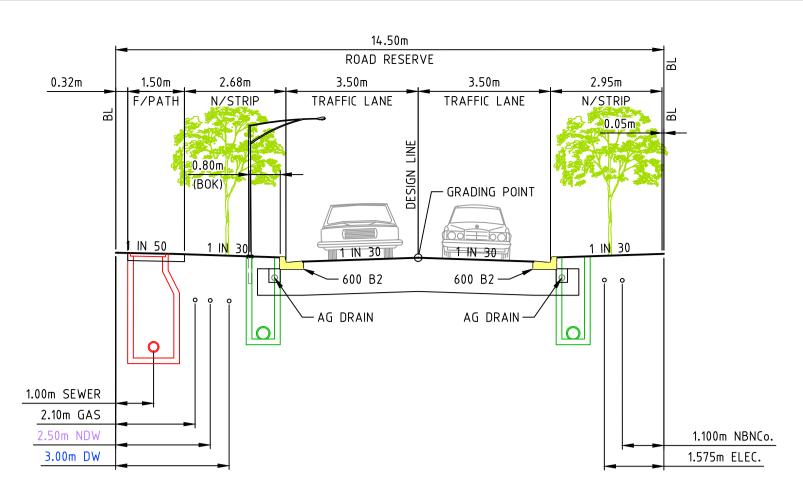


STANDARD ACCESS STREET (14.5m)

HANGER STREET SCALE 1:100 SEWER AND DRAINAGE SHOWN INDICATIVELY; REFER TO DETAIL PLAN FOR ACTUAL LOCATION

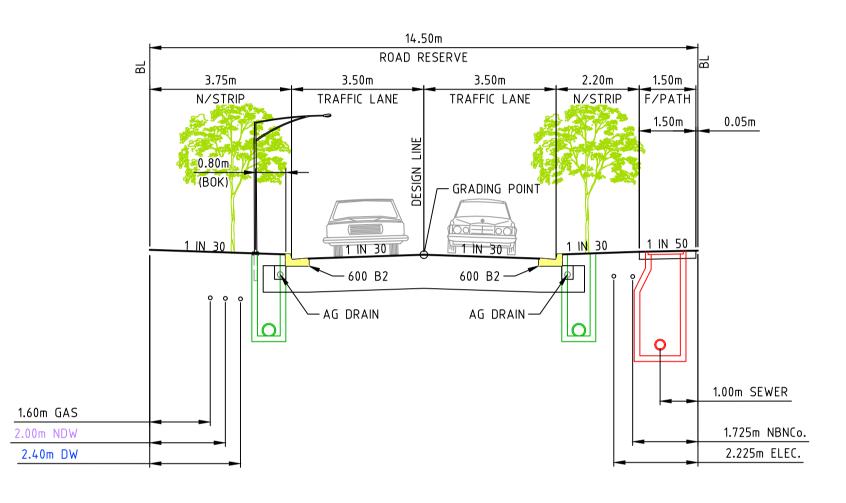

STANDARD ACCESS STREET (14.5m)

KAILASH ROAD (LOTS 4009 TO 4037) SCALE 1:100 SEWER AND DRAINAGE SHOWN INDICATIVELY; REFER TO DETAIL PLAN FOR ACTUAL LOCATION

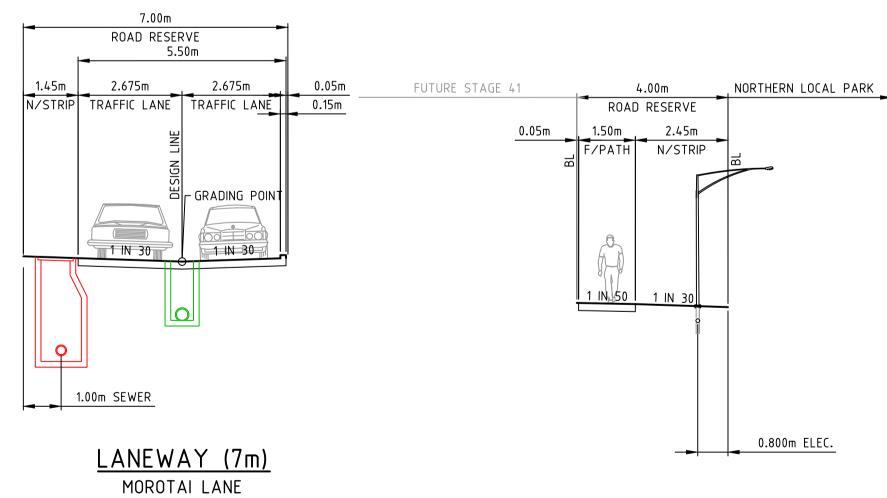

SCALE 1:100 SEWER AND DRAINAGE SHOWN INDICATIVELY;

REFER TO DETAIL PLAN FOR ACTUAL LOCATION

NORDEN WALK (4m) SCALE 1:100

1.00m SEWER

2.10m GAS

2.90m DW

16.00m ROAD RESERVE 0.05m1.50m 2.95m 3.50m 2.95m 1.50m TRAFFIC LANE TRAFFIC LANE — GRADING POINT 1 N/50 | ── 600 B2 600 B2 — — AG DRAIN AG DRAIN-2.10m GAS 2.50m NDW 1.725m NBNCo. 2.90m DW 2.50m ELEC.

STANDARD ACCESS STREET (16m)

KAILASH ROAD (LOTS 4006-4008) SCALE 1:100

SEWER AND DRAINAGE SHOWN INDICATIVELY; REFER TO DETAIL PLAN FOR ACTUAL LOCATION

16.00m ROAD RESERVE 0.05m1.50m 3.50 m2.95m F/PATH TRAFFIC LANE F/PATH TRAFFIC LANE — GRADING POINT 1 IN 30 — AG DRAIN AG DRAIN-

STANDARD ACCESS STREET (16m)

SORTIE STREET SCALE 1:100

SEWER AND DRAINAGE SHOWN INDICATIVELY; REFER TO DETAIL PLAN FOR ACTUAL LOCATION

> NOTE: PAVEMENT JOINTS
> ROAD PAVEMENT JOINTS TO BE INSTALLED IN ACCORDANCE WITH EDCM STANDARD DRAWING 201.

1.725m NBNCo.

2.25m ELEC.

NOTE: AG DRAINS

AG DRAINS TO BE INSTALLED IN ACCORDANCE WITH EDCM STANDARD DRAWING 202a.

NOTE: LIGHT POLES AND STREET TREES LOCATIONS OF LIGHT POLES SHOWN ON ALL TYPICAL SECTIONS ARE ONLY INDICATIVE AND NOT THE EXACT LOCATION OF PROPOSED LIGHT POLES. PROPOSED TREES SHALL BE CLEAR OF SERVICES AND

DAMAGE TO ABUTTING SERVICES.

LOCATED AT A SUITABLE LOCATION THAT WILL MINIMISE

TABLE OF SERVICE LOCATIONS

| STREET NAME | SEW | DW | NDW | GAS | OF | ELEC | POLES | вок |
|-----------------------------|----------|--------|--------|--------|---------|---------|---------|-------------|
| GRAMPIANS AVENUE | 1.00 E/W | 3.05 E | 2.55 E | 2.10 E | 1.725 W | 2.50 W | *0.80 S | 4.35 |
| KAILASH ROAD LOTS 4006-4008 | - | 2.90 E | 2.50 E | 2.10 E | 1.725 W | 2.50 W | *0.80 S | 4.35 |
| KAILASH ROAD LOTS 4009-4037 | 1.00 S | 2.40 N | 2.00 N | 1.60 E | 1.725 S | 2.225 S | *0.80 S | 3.60 |
| BATCHELOR STREET | 1.00 S | 2.90 S | 2.50 S | 2.10 S | 2.00 N | 2.50 N | *0.80 S | 4.35 |
| MOROTAI LANE | 1.00 N | - | - | - | - | - | - | - |
| SORTIE STREET | 1.00 W | 2.90 W | 2.50 W | 2.10 W | 1.725 E | 2.25 E | *0.80 S | 4.35 |
| HANGER STREET | 1.00 S | 3.00 S | 2.50 S | 2.10 S | 1.100 N | 1.575 N | *0.80 S | 4.35E/2.85W |

* FROM BACK OF KERB

R.GUTIERREZ NOT TO BE USED FOR 14/09/22 3401095 CONSTRUCTION Designed P.NICHOLSON 13/09/22 Date 3791018 COUNCIL COMMENTS 29/11/22 |30/11/22| PN/SR | TL Checked S.RAJKOVIC Date 21/09/22 C COUNCIL COMMENTS 24/10/22 17/11/22 GA 2951057 B COUNCIL ISSUE 21/09/22 PN/RG 14/09/22 PN/NR | TL | Date A TENDER ISSUE REV DESCRIPTION Written dimensions to take precedence over scale. Contractor shall check and verify all dimensions on site. Discrepancies to be brought to the attention of the Superintendent.

APPROX. 7.30 - 8.5 (VARIES)

MAINS DESIGN DRAWINGS)

EX. GAS TO BE REMOVED





1:100 / 1:200


Scale @ A1/A3


RIVERWALK STAGE 40 GEELONG ROAD, WERRIBEE WYNDHAM CITY COUNCIL **TYPICAL SECTIONS**

Drawing No. 10940TD03 Rev D Sheet No. 03 of 40



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FINISHED SURFACE LEVEL

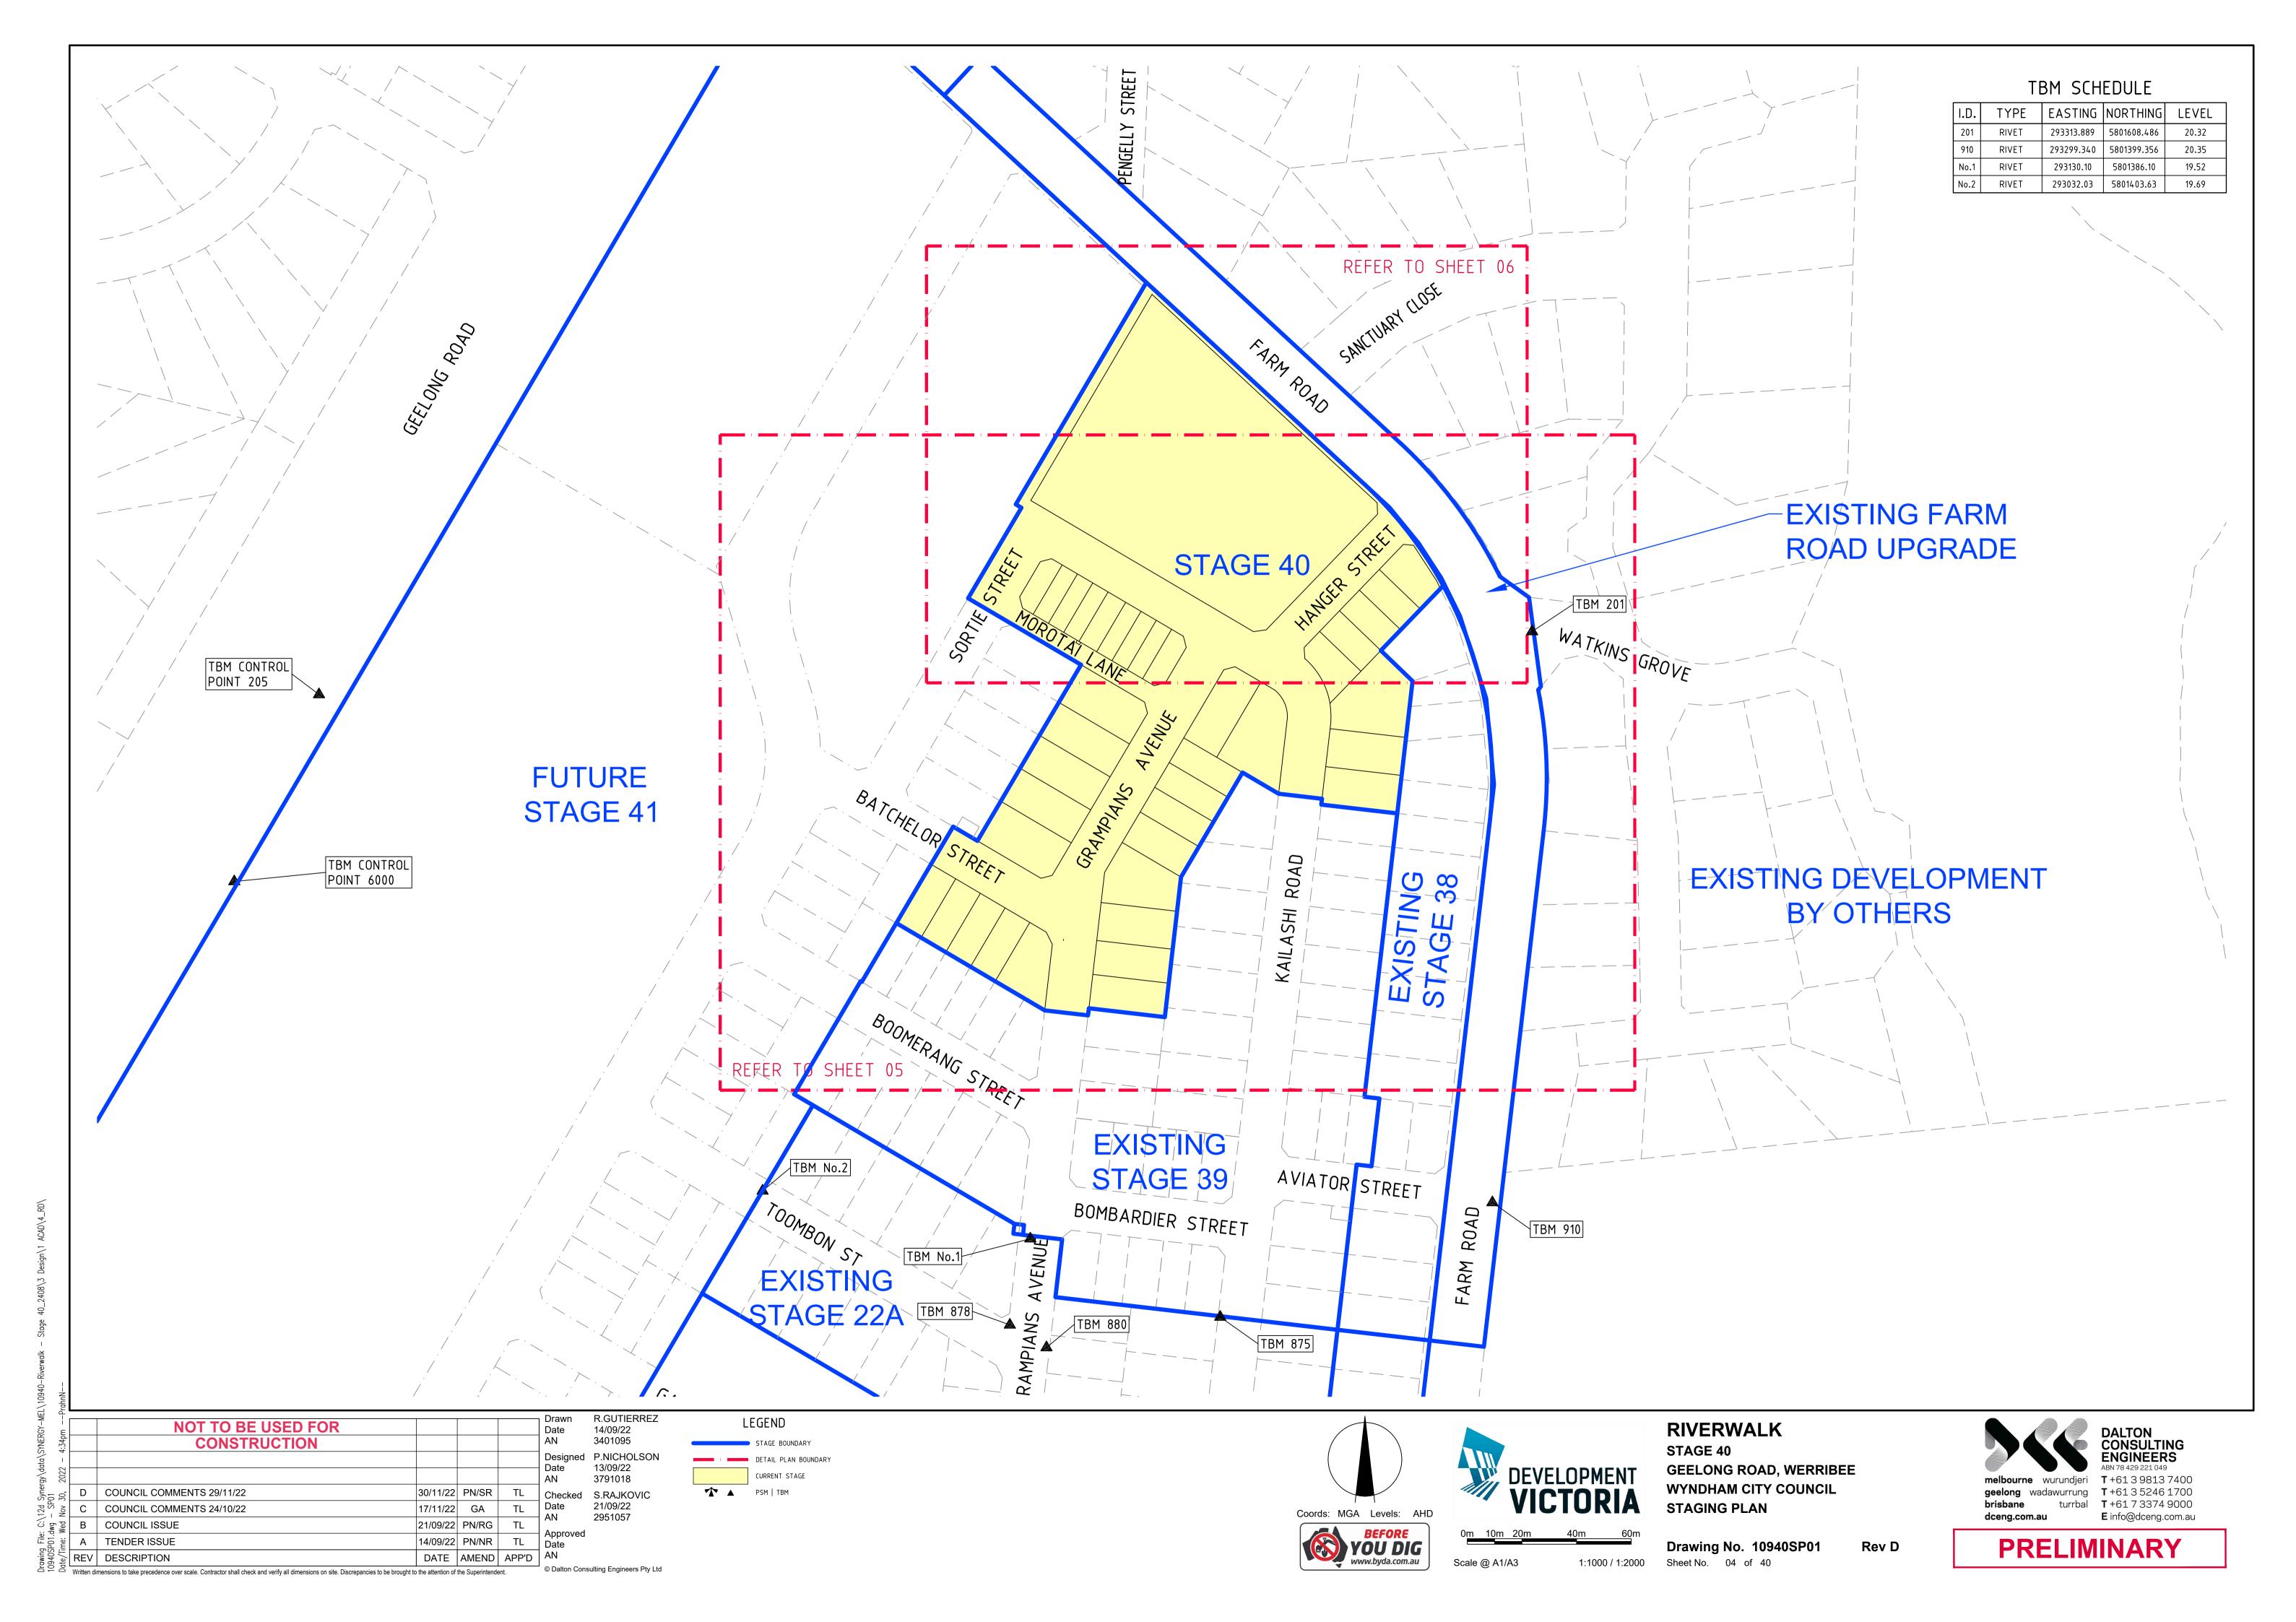EX. SURFACE LEVEL TOP OF BATTER LEVEL

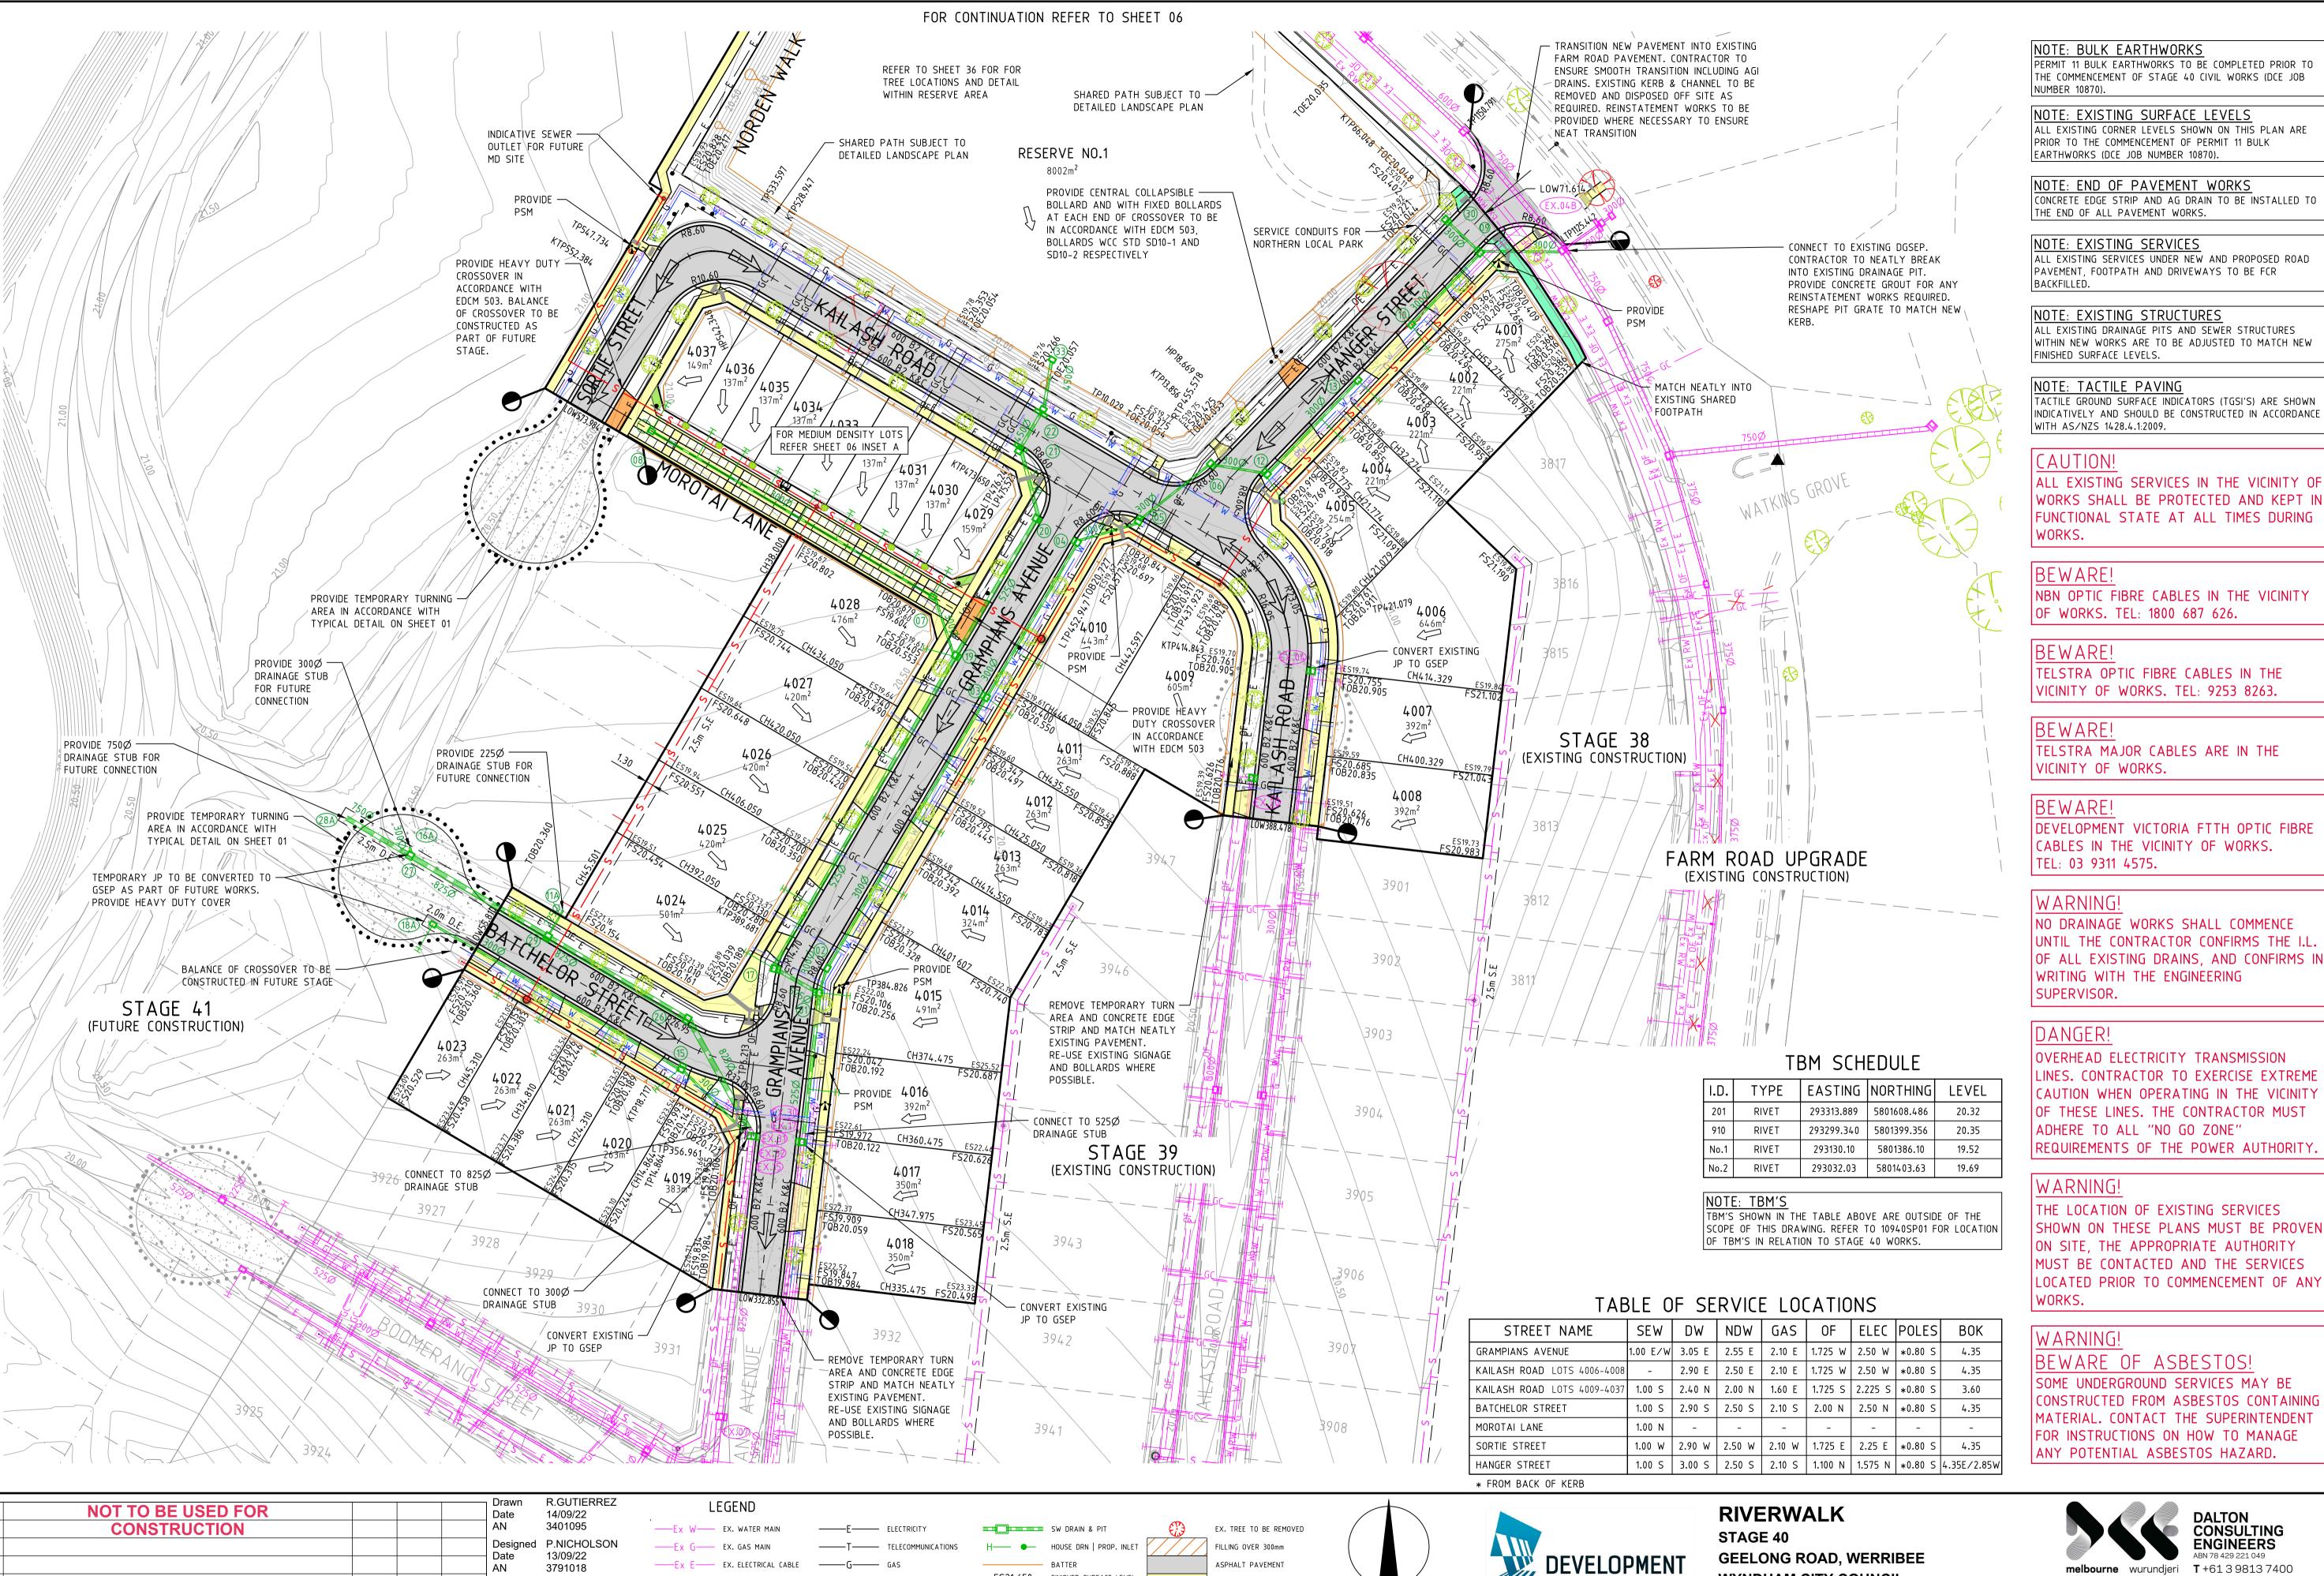TOE OF BATTER LEVEL

REGRADE LOT (MIN 1:150)

PROPOSED TREE

EX. TREE TO REMAIN

T0E21.650

CONCRETE PATH | D'WAY

HEAVY DUTY CROSSOVER

CONCRETE SHARED PATH

LANDSCAPING

TURN AREA

Coords: MGA Levels: AHD

www.byda.com.au

Scale @ A1/A3

COUNCIL COMMENTS 29/11/22

Written dimensions to take precedence over scale. Contractor shall check and verify all dimensions on site. Discrepancies to be brought to the attention of the Superintendent.

C COUNCIL COMMENTS 24/10/22

B | COUNCIL ISSUE

REV DESCRIPTION

TENDER ISSUE

30/11/22 PN/SR

17/11/22 GA

21/09/22 PN/RG

14/09/22 PN/NR

DATE AMEND APP'D

—Ex S—O— EX. SEWER MAIN & MH

■ SIGNAGE

→ PSM | TBM

RECYCLED WATER

DW/NDW/GAS CONDUITS

LIMIT OF WORKS

S.RAJKOVIC

21/09/22

2951057

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Checked

Date

DALTON CONSULTING geelong wadawurrung T+61352461700

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WYNDHAM CITY COUNCIL

Drawing No. 10940DP01

Rev D

DETAIL PLAN

1:500 / 1:1000

SHEET 01 OF 02

Sheet No. 05 of 40

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PROVIDE GRATED PIT WITH HEAVY DUTY PIT COVER PROVIDE HEAVY DUTY CROSSOVER IN ACCORDANCE WITH EDCM 503. BALANCE OF CROSSOVER TO BE CONSTRUCTED AS PART OF FUTURE STAGE. HOUSE DRAINS FOR LOTS 4029-4037 TO BE PROVIDED WITH -FITZROY BOXES SPACED 1M FROM INVERT OF LANEWAY PROVIDE GRATED PIT WITH HEAVY PROPOSED LIGHT POLE. REFER TO -DUTY PIT COVER ELECTRICAL PLANS. BOLLARDS TO BE IN ACCORDANCE WITH WCC SD10-2.

INSET A MEDIUM DENSITY LOTS 4029 TO 4037 SCALE @ A1/A3 1:250/1:500

NOTE: END OF PAVEMENT WORKS CONCRETE EDGE STRIP AND AG DRAIN TO BE INSTALLED TO

NOTE: EXISTING SERVICES ALL EXISTING SERVICES UNDER NEW AND PROPOSED ROAD PAVEMENT, FOOTPATH AND DRIVEWAYS TO BE FCR BACKFILLED.

NOTE: EXISTING STRUCTURES

ALL EXISTING DRAINAGE PITS AND SEWER STRUCTURES WITHIN NEW WORKS ARE TO BE ADJUSTED TO MATCH NEW FINISHED SURFACE LEVELS.

NOTE: TACTILE PAVING TACTILE GROUND SURFACE INDICATORS (TGSI'S) ARE SHOWN INDICATIVELY AND SHOULD BE CONSTRUCTED IN ACCORDANCE WITH AS/NZS 1428.4.1:2009.

CAUTION!

ALL EXISTING SERVICES IN THE VICINITY OF WORKS SHALL BE PROTECTED AND KEPT IN FUNCTIONAL STATE AT ALL TIMES DURING WORKS.

BEWARE!

NBN OPTIC FIBRE CABLES IN THE VICINITY OF WORKS. TEL: 1800 687 626.

BEWARE!

TELSTRA OPTIC FIBRE CABLES IN THE VICINITY OF WORKS, TEL: 9253 8263.

BEWARE!

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DANGER!

OVERHEAD ELECTRICITY TRANSMISSION LINES. CONTRACTOR TO EXERCISE EXTREME CAUTION WHEN OPERATING IN THE VICINITY OF THESE LINES. THE CONTRACTOR MUST ADHERE TO ALL "NO GO ZONE" REQUIREMENTS OF THE POWER AUTHORITY.

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TABLE OF SERVICE LOCATIONS

| 1712 | | · | 1 7 1 6 1 | | -/ (10 | 110 | | |
|-----------------------------|----------|--------|-----------|--------|-----------|---------|---------|-------------|
| STREET NAME | SEW | DW | NDW | GAS | OF | ELEC | POLES | вок |
| GRAMPIANS AVENUE | 1.00 E/W | 3.05 E | 2.55 E | 2.10 E | 1.725 W | 2.50 W | *0.80 S | 4.35 |
| KAILASH ROAD LOTS 4006-4008 | - | 2.90 E | 2.50 E | 2.10 E | 1.725 W | 2.50 W | *0.80 S | 4.35 |
| KAILASH ROAD LOTS 4009-4037 | 1.00 S | 2.40 N | 2.00 N | 1.60 E | 1.725 S | 2.225 S | *0.80 S | 3.60 |
| BATCHELOR STREET | 1.00 S | 2.90 S | 2.50 S | 2.10 S | 2.00 N | 2.50 N | *0.80 S | 4.35 |
| MOROTAI LANE | 1.00 N | 1 | - | - | - | _ | - | - |
| SORTIE STREET | 1.00 W | 2.90 W | 2.50 W | 2.10 W | 1.725 E | 2.25 E | *0.80 S | 4.35 |
| HANGER STREET | 1.00 S | 3.00 S | 2.50 S | 2.10 S | 1.100 N | 1.575 N | *0.80 S | 4.35E/2.85W |
| * FROM BACK OF KERB | | | | | | | | |

TBM SCHEDULE

| IDII SCHEDOLL | | | | | | | | |
|---------------|-------|------------|-------------|-------|--|--|--|--|
| I.D. | TYPE | EASTING | NORTHING | LEVEL | | | | |
| 201 | RIVET | 293313.889 | 5801608.486 | 20.32 | | | | |
| 910 | RIVET | 293299.340 | 5801399.356 | 20.35 | | | | |
| No.1 | RIVET | 293130.10 | 5801386.10 | 19.52 | | | | |
| No.2 | RIVET | 293032.03 | 5801403.63 | 19.69 | | | | |

NOTE: TBM'S


TBM'S SHOWN IN THE TABLE ABOVE ARE OUTSIDE OF THE SCOPE OF THIS DRAWING. REFER TO 10940SP01 FOR LOCATION OF TBM'S IN RELATION TO STAGE 40 WORKS.


NOT TO BE USED FOR Date CONSTRUCTION D COUNCIL COMMENTS 29/11/22 |30/11/22| PN/SR | TL Date C COUNCIL COMMENTS 24/10/22 17/11/22 GA B | COUNCIL ISSUE 21/09/22 PN/RG ë A TENDER ISSUE 14/09/22 PN/NR REV DESCRIPTION


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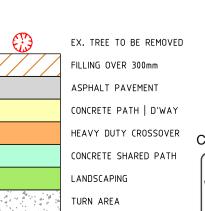


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NUMBER 10870).

NOTE: BULK EARTHWORKS

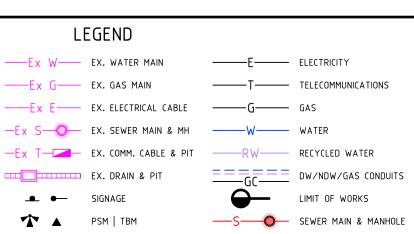NOTE: EXISTING SURFACE LEVELS

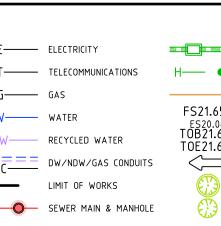EARTHWORKS (DCE JOB NUMBER 10870).

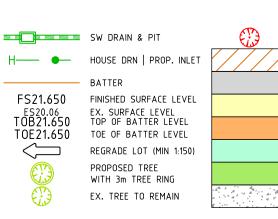PRIOR TO THE COMMENCEMENT OF PERMIT 11 BULK

PERMIT 11 BULK EARTHWORKS TO BE COMPLETED PRIOR TO

THE COMMENCEMENT OF STAGE 40 CIVIL WORKS (DCE JOB

ALL EXISTING CORNER LEVELS SHOWN ON THIS PLAN ARE



1:500 / 1:1000


RIVERWALK STAGE 40 **GEELONG ROAD, WERRIBEE** WYNDHAM CITY COUNCIL **DETAIL PLAN SHEET 02 OF 02** Drawing No. 10940DP02 Rev D

Sheet No. 06 of 40





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ALIGNMENT A NORTHING 5801493.105 5801495.794 5801505.124 5801508.696 POINT NO 2 9 3 1 4 3 . 0 2 3 2 9 3 1 4 3 . 3 3 4 2 9 3 1 3 6 . 8 8 7 2 9 3 1 2 8 . 1 7 4 19.719 19.733 19.787 19.773 CURVE NO A2 - A3 A3 - A4 ALIGNMENT B POINT NO 5801513.952 5801512.526 5801519.404 5801520.785 5801526.552 19.773 19.789 19.869 19.872 19.883 2 9 3 1 3 4 . 0 4 8 2 9 3 1 4 6 . 0 6 6 2 9 3 1 4 6 . 2 2 6 2 9 3 1 4 8 . 1 6 0 CURVE NO B1 - B2 B2 - B3 B4 - B5 MID POINT RL 19.781 19.829 19.868 0 . 7 8 1 3 . 0 4 5 1 . 5 1 2 3.126 16.096 6.127 0.045 3.499 0.318 0.034 2.574 0.238 0.781 3.879 1.529 <u>ALIGNMENT</u> C E A S T I N G 2 9 3 1 5 3 . 4 1 7 2 9 3 1 5 2 . 2 8 6 Point no CURVE NO C1 - C2 MID POINT RL 19.871 23.880 0.139 0.894



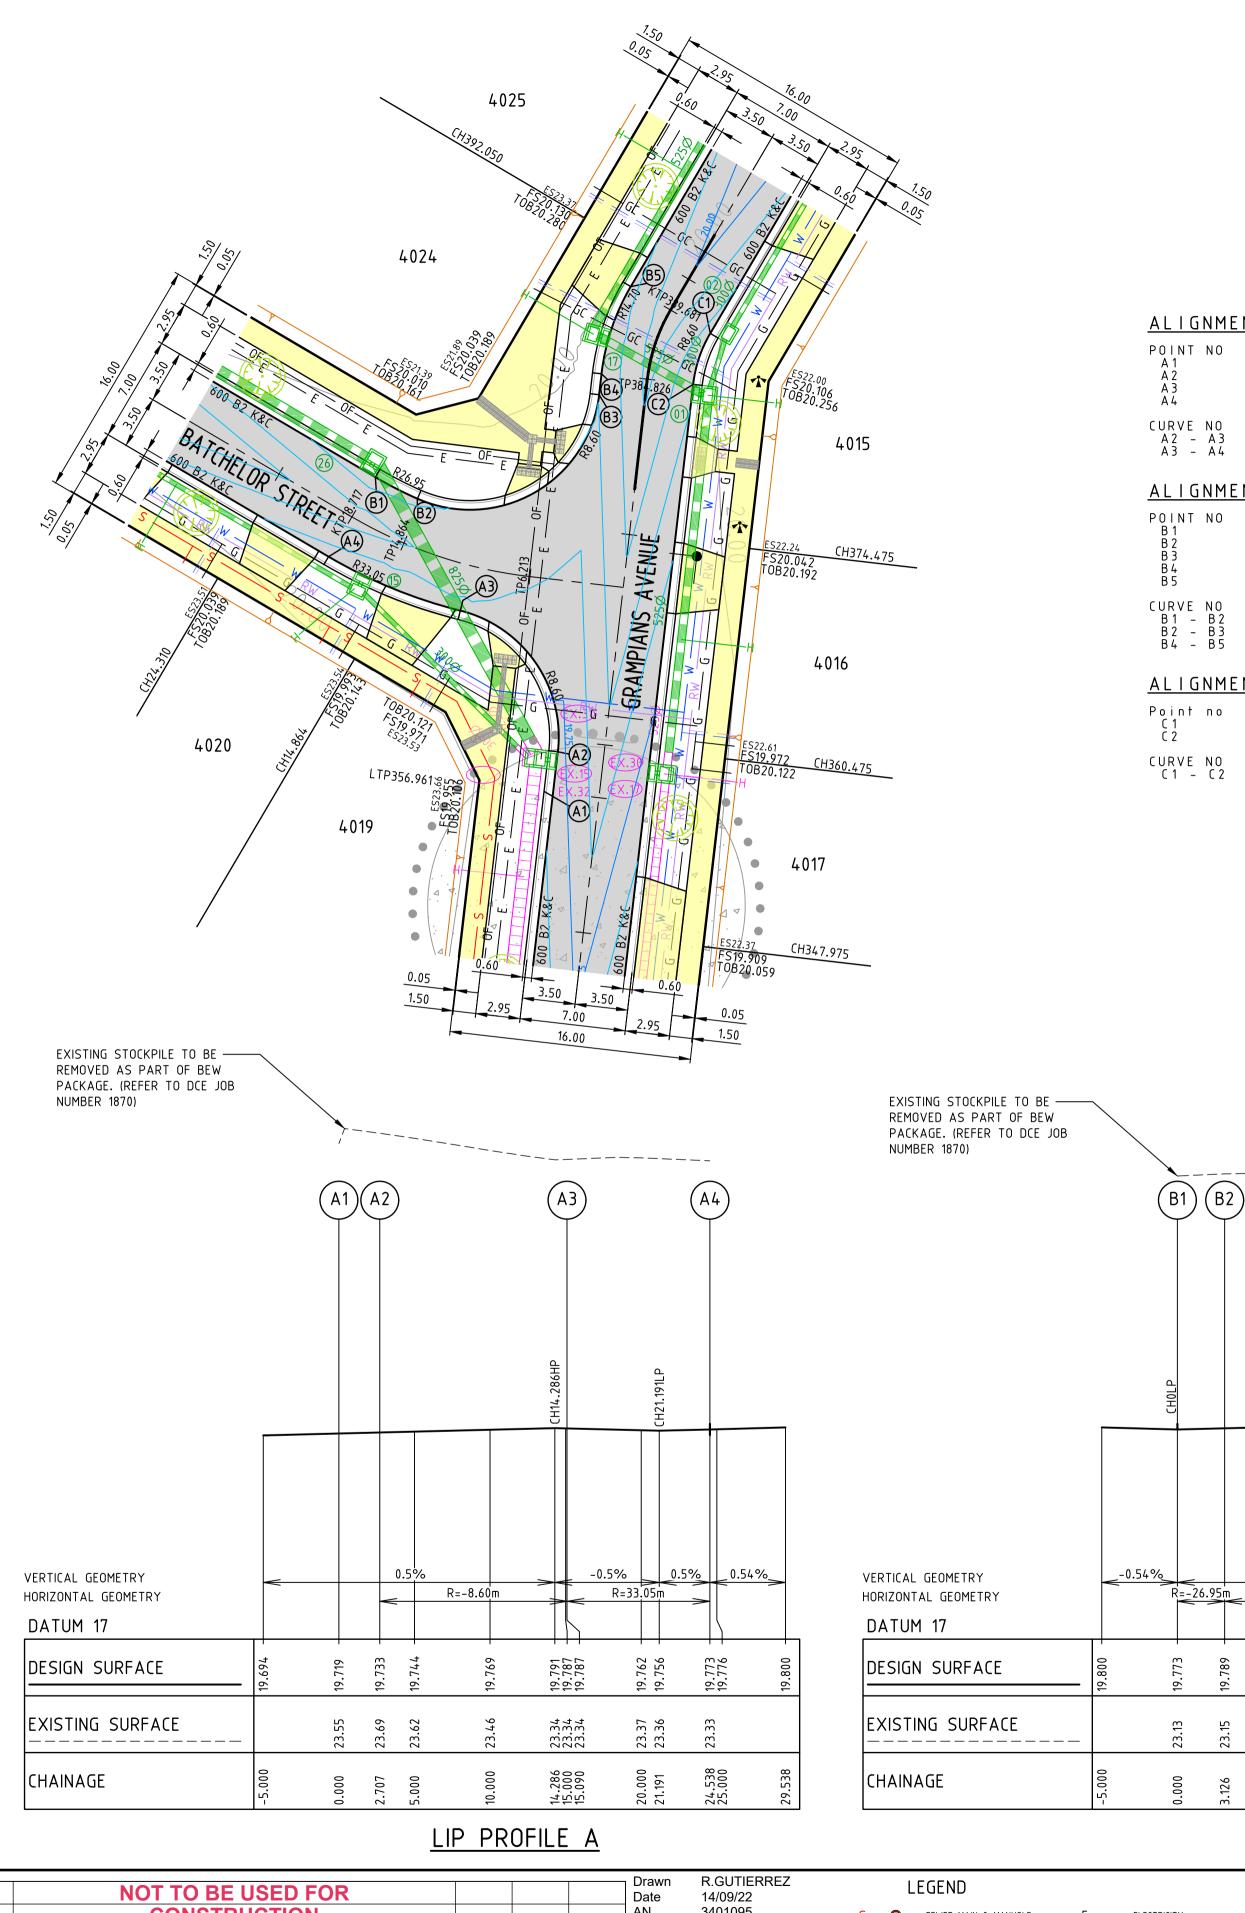

NOT TO SCALE
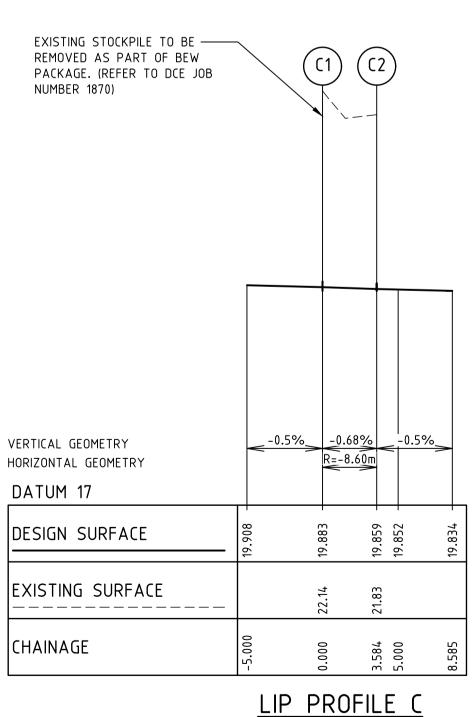
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THE END OF ALL PAVEMENT WORKS.
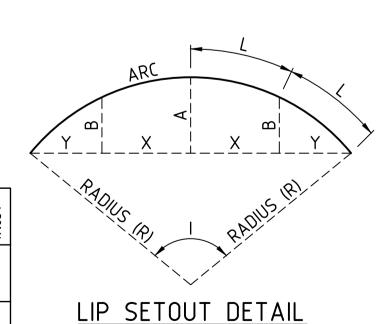
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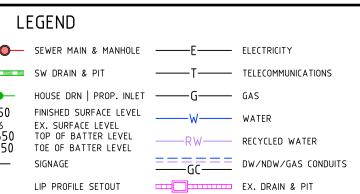
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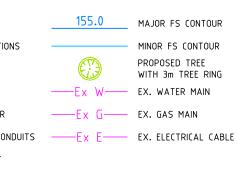
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| Prahn∖ | | | | | | | |
|----------|-------------|---|--------------------|------------------|-------|------------------------|------------------------------------|
| 4:35pmF | | NOT TO BE USED FOR CONSTRUCTION | | | | Drawn Date AN | R.GUTIERREZ 14/09/22 3401095 |
| 2022 - 4 | | | | | | Designed Date AN | P.NICHOLSON 13/09/22 3791018 |
| 30, | D | COUNCIL COMMENTS 29/11/22 | 30/11/22 | PN/SR | TL | Checked | S.RAJKOVIC |
| Nov | С | COUNCIL COMMENTS 24/10/22 | 17/11/22 | GA | TL | Date | 21/09/22 2951057 |
| Wed | В | COUNCIL ISSUE | 21/09/22 | PN/RG | TL | Annroyad | 2951057 |
| /Time: | Α | TENDER ISSUE | 14/09/22 | PN/NR | TL | Approved Date | |
| Date/Ti | REV | DESCRIPTION | DATE | AMEND | APP'D | AN | |
| <u>a</u> | Written dir | nensions to take precedence over scale. Contractor shall check and verify all dimensions on site. Discrepancies to be brought t | o the attention of | the Superintende | ent. | © Dalton Cons | sulting Engineers Pty Ltd |


| TIERREZ 1/22 | LE | EGEND | | |
|-----------------|---|--|---------------|---------------------|
| 095 | —S——— | SEWER MAIN & MANHOLE | ——Е—— | ELECTRICITY |
| CHOLSON 0/22 | | SW DRAIN & PIT | T | TELECOMMUNICATIONS |
| 018 | H | HOUSE DRN PROP. INLET | <u>——</u> G—— | GAS |
| JKOVIC | FS21.650 ES20.06 TOB21.650 TOE21.650 | FINISHED SURFACE LEVEL EX. SURFACE LEVEL TOP OF BATTER LEVEL TOE OF BATTER LEVEL | ——W—— | WATER |
| 1/22 057 | | | RW | RECYCLED WATER |
| 331 | - - | SIGNAGE | GC | DW/NDW/GAS CONDUITS |
| | (A1) | LIP PROFILE SETOUT | | EX. DRAIN & PIT |
| | —Ех Т——— | EX. COMM. CABLE & PIT | —Ex S—О— | EX. SEWER MAIN & MH |





R = -8.60 m

LIP PROFILE B

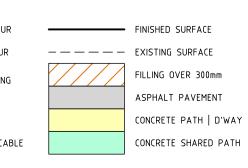


___ R=14.70m __

21.86 21.84 21.84 21.83 21.78 22.01

.869 .873 .874 .872 .872

9.9.3

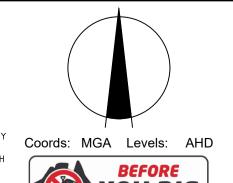



H1:250/500 V1:50/100


Scale @ A1/A3

RIVERWALK STAGE 40 **GEELONG ROAD, WERRIBEE** WYNDHAM CITY COUNCIL **INTERSECTION DETAILS SHEET 01 OF 05** Drawing No. 10940ID01 Rev D




DALTON CONSULTING melbourne wurundjeri T+61398137400 **geelong** wadawurrung **T** +61 3 5246 1700 turrbal **T** +61 7 3374 9000 dceng.com.au

E info@dceng.com.au

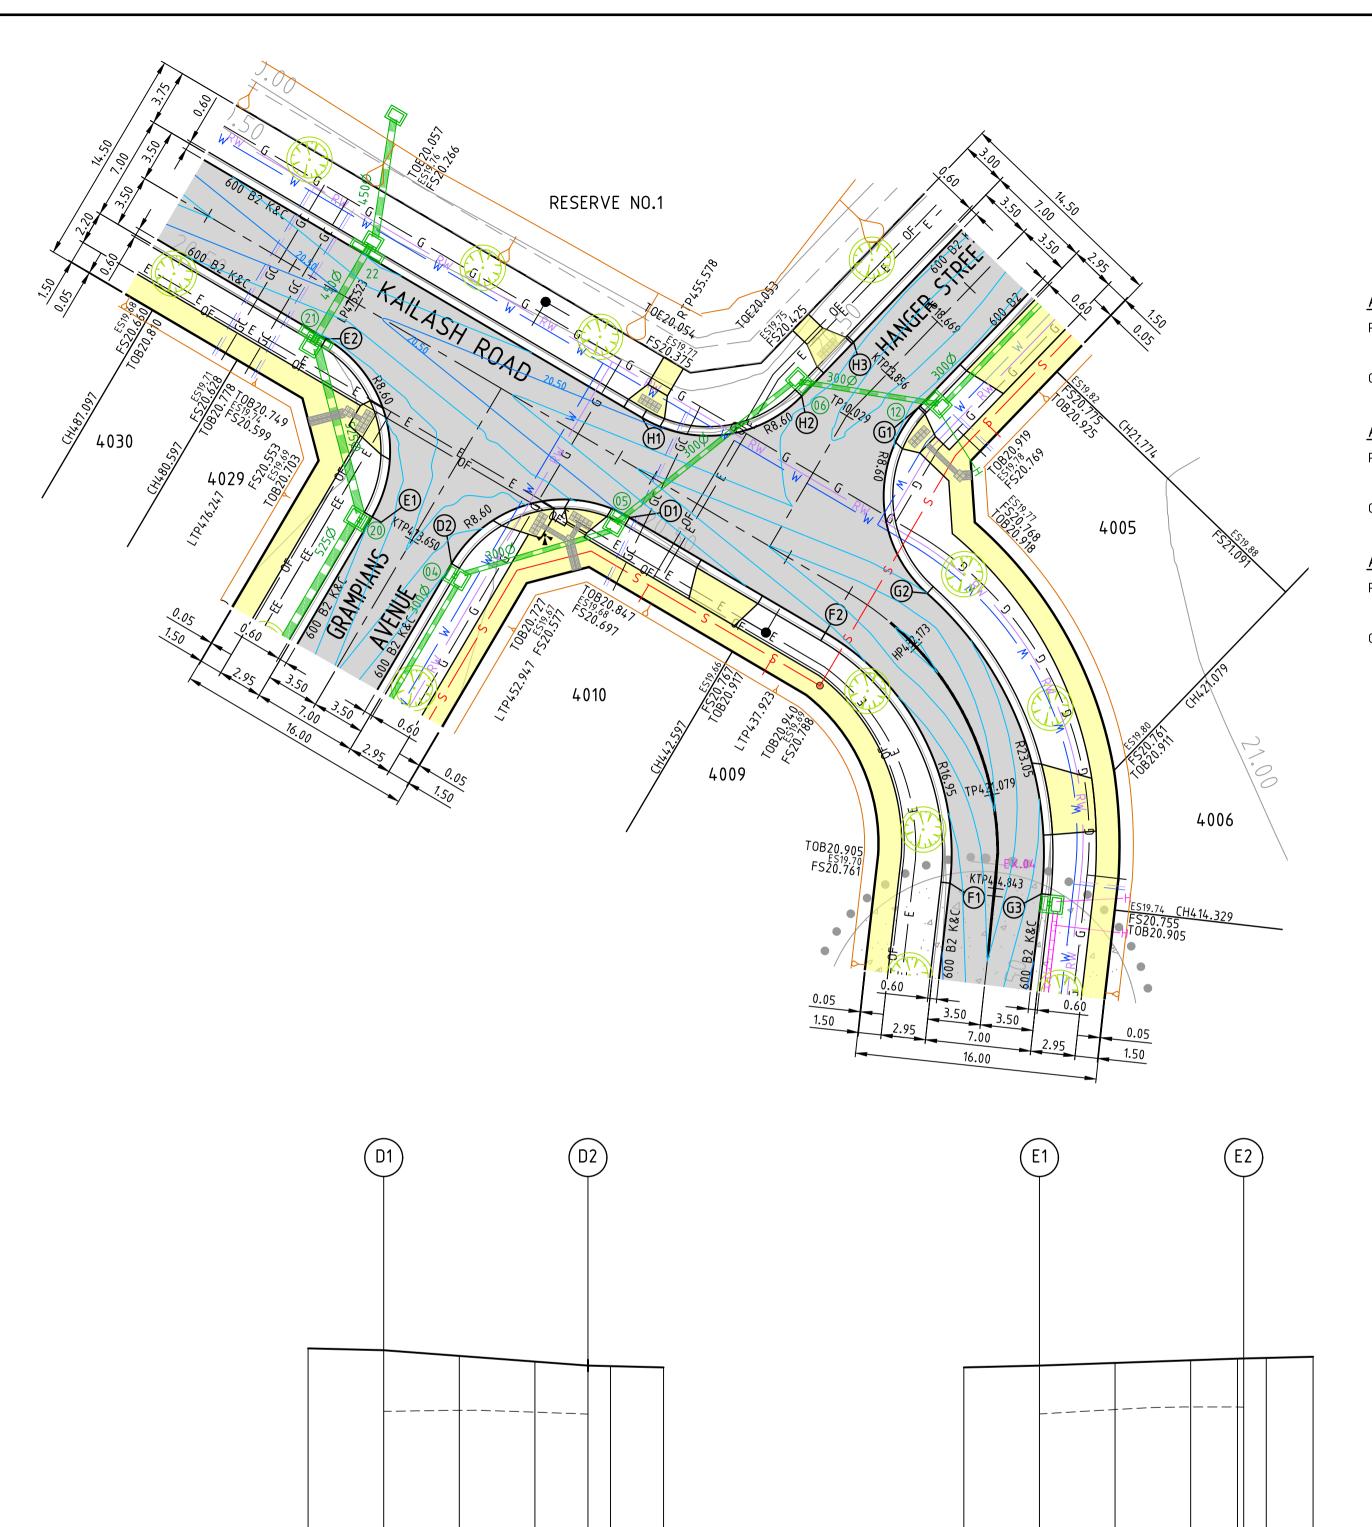

<u>ALIGNMENT D</u> POINT NO D1 D2 CURVE NO D1 - D2 L MID POINT RL 3.377 20.404 2.519 <u>ALIGNMENT E</u> E A S T I N G 2 9 3 1 9 0 . 7 5 4 2 9 3 1 8 7 . 7 0 5 NORTHING 5801598.916 5801610.689 POINT NO CURVE NO E1 - E2 L MID POINT RL 3.377 20.350 <u>ALIGNMENT F</u> POINT NO 293228.972 293220.732 F 1 F 2 L MID POINT RL 4.890 20.580 66.120

-0.59% _ 0.5% _ 0.59% _ -0.5% _ VERTICAL GEOMETRY R=-16.95m HORIZONTAL GEOMETRY DATUM 17 20.603 20.606 20.606 20.603 20.581 20.578 20.553 20.553 DESIGN SURFACE EXISTING SURFACE 19.72 19.71 19.71 19.71 CHAINAGE 13.687 14.687 15.000 15.687 LIP PROFILE F

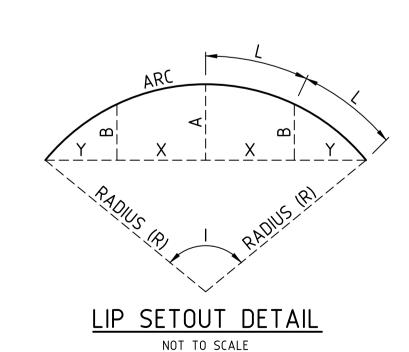

NOTE: END OF PAVEMENT WORKS

CONCRETE EDGE STRIP AND AG DRAIN TO BE INSTALLED TO THE END OF ALL PAVEMENT WORKS.

NOTE: EXISTING SERVICES

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| 5 | | | | | | |
|---------|---|---------------------------------|----------|-------|----|---------------------|
| . Indoo | | NOT TO BE USED FOR CONSTRUCTION | | | | Drawn Date AN |
| | | | | | | Designed Date AN |
| , | D | COUNCIL COMMENTS 29/11/22 | 30/11/22 | PN/SR | TL | Checked |
| | С | COUNCIL COMMENTS 24/10/22 | 17/11/22 | GA | TL | Date |
| 5 | В | COUNCIL ISSUE | 21/09/22 | PN/RG | TL | Annroyed |
| | Α | TENDER ISSUE | 14/09/22 | PN/NR | TL | Approved Date |
| | | | | | | |

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-0.5%

VERTICAL GEOMETRY

DATUM 17

CHAINAGE

HORIZONTAL GEOMETRY

DESIGN SURFACE

EXISTING SURFACE

-1.5%

R=-8.60m

LIP PROFILE D

DATE AMEND APP'D AN

-0.5%_

| GUTIERREZ I/09/22 I/01095 | —s— |
|---------------------------------|-----------------------------------|
| NICHOLSON 8/09/22 791018 | H |
| RAJKOVIC 1/09/22 951057 | FS21. ES20. TOB21 TOE21. |
| | —Fx T- |

VERTICAL GEOMETRY

DATUM 17

CHAINAGE

HORIZONTAL GEOMETRY

DESIGN SURFACE


EXISTING SURFACE

| LE | EGEND | | |
|-------------------------|--|--|---------------------|
| — | SEWER MAIN & MANHOLE | ——Е—— | ELECTRICITY |
| | SW DRAIN & PIT | T | TELECOMMUNICATIONS |
| • | HOUSE DRN PROP. INLET | <u>——</u> G—— | GAS |
| .650 _{0.06} | FINISHED SURFACE LEVEL EX. SURFACE LEVEL | ——W—— | WATER |
| 1.650 1.650 | TOP OF BATTER LEVEL TOE OF BATTER LEVEL | RW | RECYCLED WATER |
| •— | SIGNAGE | ====================================== | DW/NDW/GAS CONDUI |
| \mathfrak{J} | LIP PROFILE SETOUT | | EX. DRAIN & PIT |
| | EX. COMM. CABLE & PIT | -Ex S- ⊙ - | EX. SEWER MAIN & MI |

_ 0.5% _


R=-8.60m

LIP PROFILE E

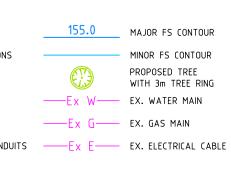

19.75 19.75

13.094 13.509 15.000

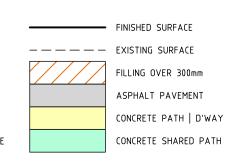





1:250 / 1:500

Scale @ A1/A3


RIVERWALK STAGE 40 **GEELONG ROAD, WERRIBEE** WYNDHAM CITY COUNCIL **INTERSECTION DETAILS SHEET 02 OF 05** Drawing No. 10940ID02 Rev D


Sheet No. 08 of 40



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turrbal **T** +61 7 3374 9000 E info@dceng.com.au



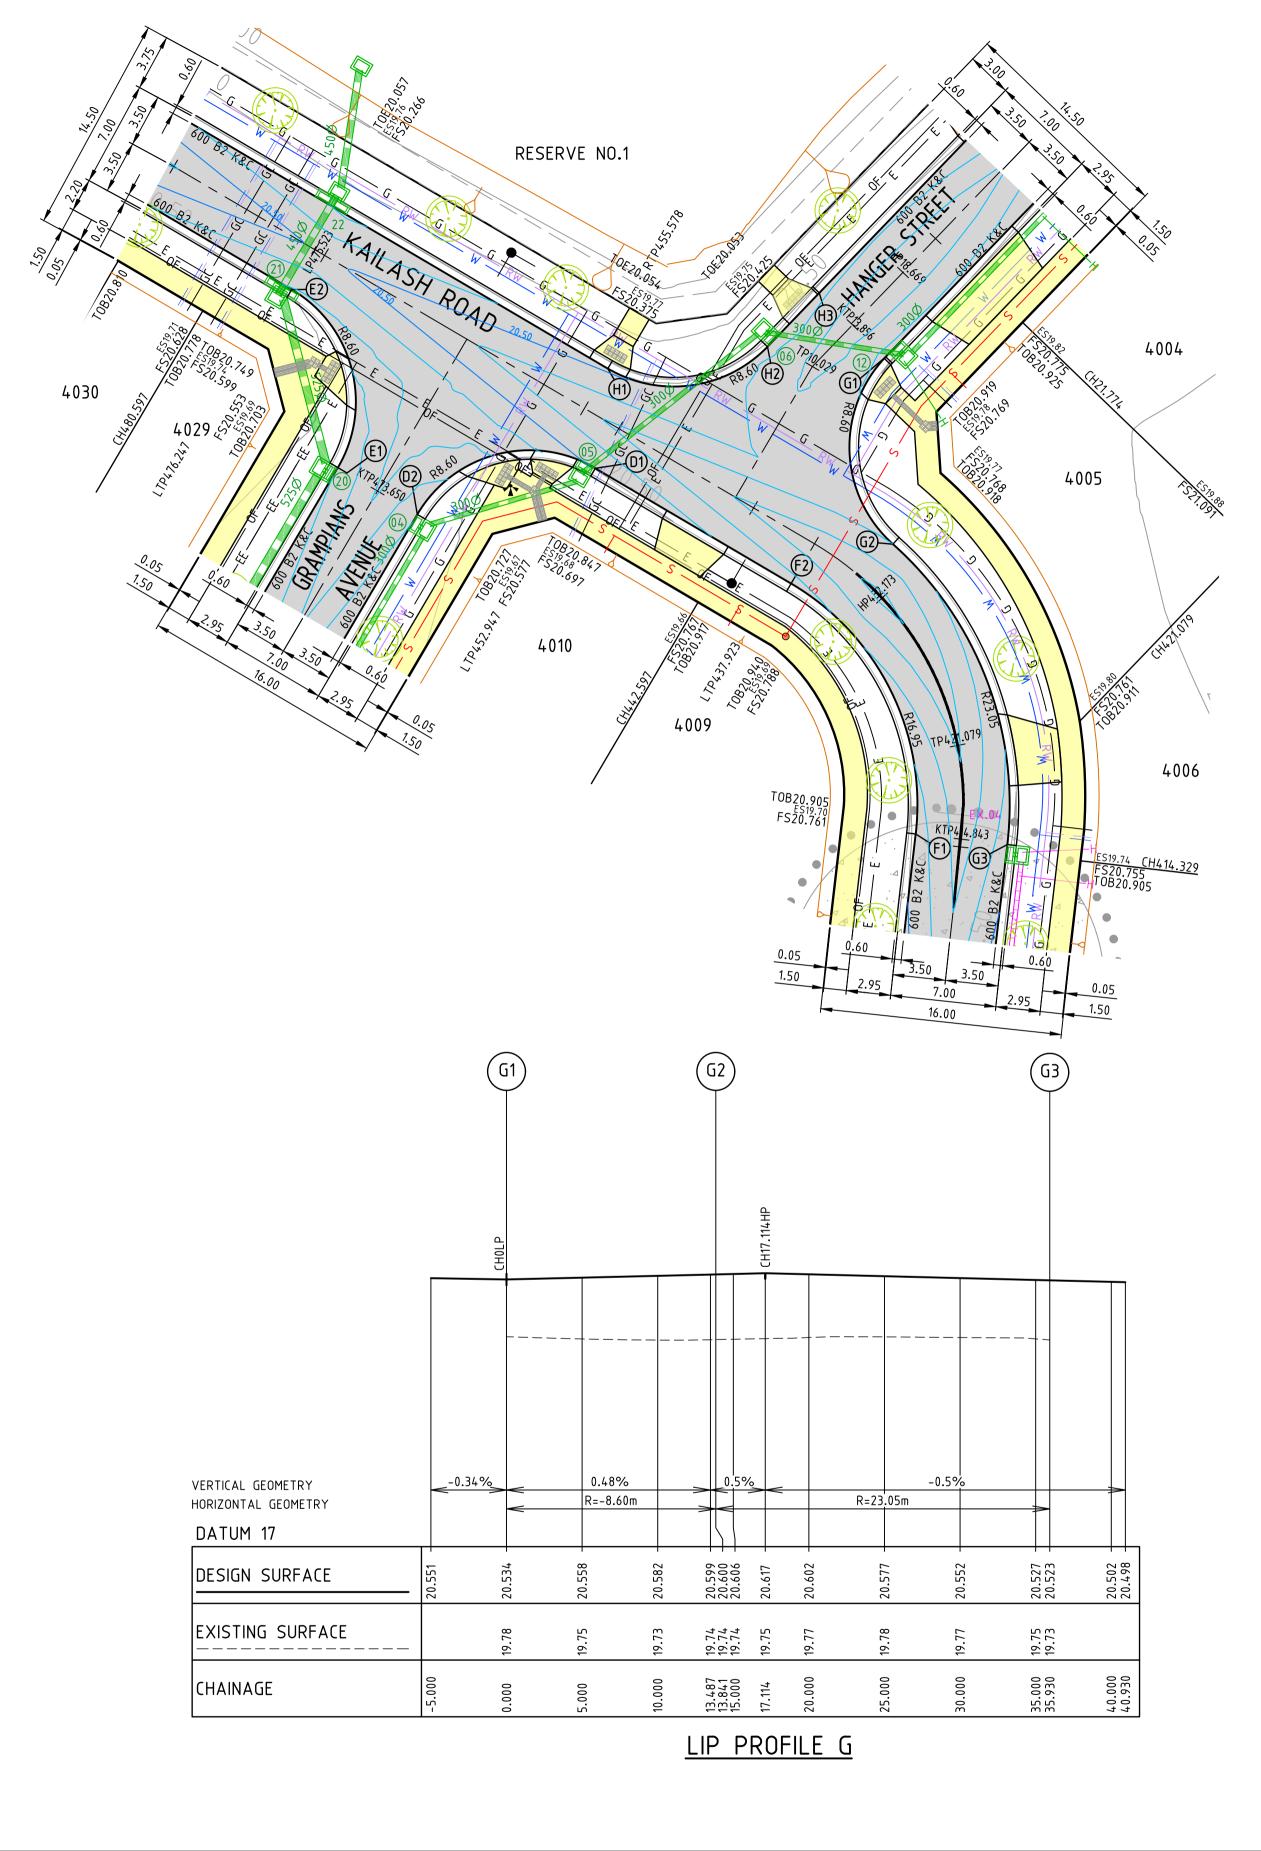

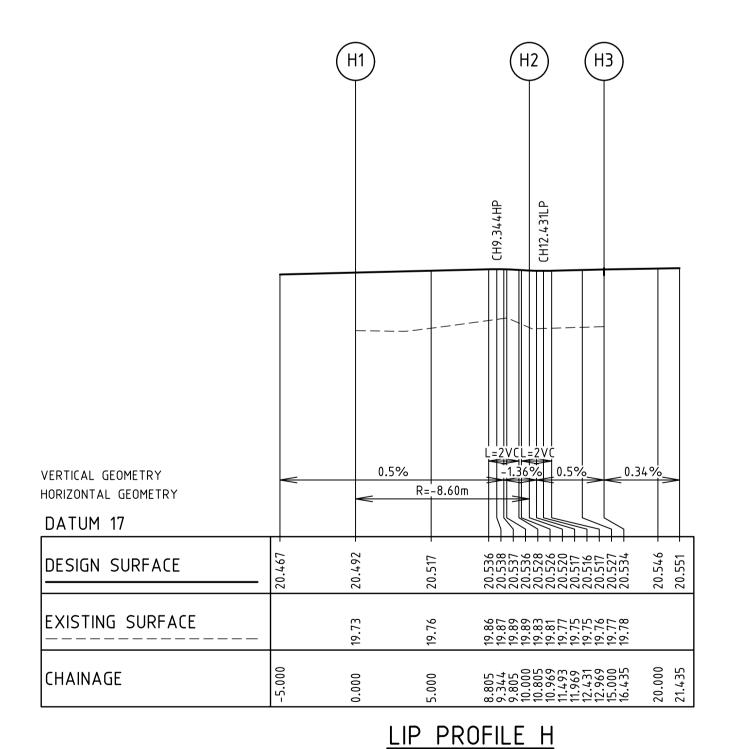LIP SETOUT DETAIL

NOT TO SCALE

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LOCATED PRIOR TO COMMENCEMENT OF ANY
WORKS.

WARNING!

BEWARE OF ASBESTOS!


SOME UNDERGROUND SERVICES MAY BE
CONSTRUCTED FROM ASBESTOS CONTAINING
MATERIAL. CONTACT THE SUPERINTENDENT
FOR INSTRUCTIONS ON HOW TO MANAGE
ANY POTENTIAL ASBESTOS HAZARD.


| | NOT TO BE USED FOR CONSTRUCTION | | | | Drawn Date AN | R.GUTIERREZ 14/09/22 3401095 |
|---|---------------------------------|----------|-------|----|------------------------|------------------------------------|
| | | | | | Designed Date AN | P.NICHOLSON 13/09/22 3791018 |
| D | COUNCIL COMMENTS 29/11/22 | 30/11/22 | PN/SR | TL | Checked | S.RAJKOVIC |
| С | COUNCIL COMMENTS 24/10/22 | 17/11/22 | GA | TL | Date AN | 21/09/22 2951057 |
| В | COUNCIL ISSUE | 21/09/22 | PN/RG | TL | | 2901007 |
| Α | TENDER ISSUE | 14/09/22 | PN/NR | TL | Approved Date | |
| | | | | | | |

Written dimensions to take precedence over scale. Contractor shall check and verify all dimensions on site. Discrepancies to be brought to the attention of the Superintendent.

DATE AMEND APP'D AN

| Lf | EGEND | | |
|------------------------|--|--|-------------|
| <u>S</u> | SEWER MAIN & MANHOLE | ——Е—— | ELECTRICITY |
| | SW DRAIN & PIT | T | TELECOMMUN |
| H | HOUSE DRN PROP. INLET | ——G—— | GAS |
| FS21.650 ES20.06 | FINISHED SURFACE LEVEL EX. SURFACE LEVEL | ——W—— | WATER |
| T0B21.650 T0E21.650 | TOP OF BATTER LEVEL TOE OF BATTER LEVEL | RW | RECYCLED W |
| - - | SIGNAGE | ====================================== | DW/NDW/G |
| \bigcirc | LIP PROFILE SETOUT | | EX. DRAIN 8 |
| —Fx T— | EX. COMM. CABLE & PIT | -Fx S ○ - | EX. SEWER |

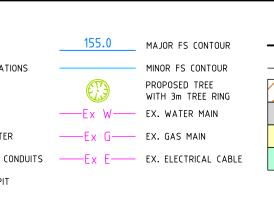


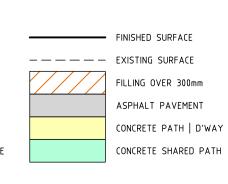



Scale @ A1/A3

H1:250/500 V1:50/100

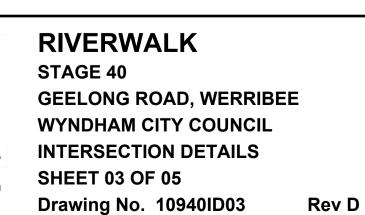

Sheet No. 09 of 40



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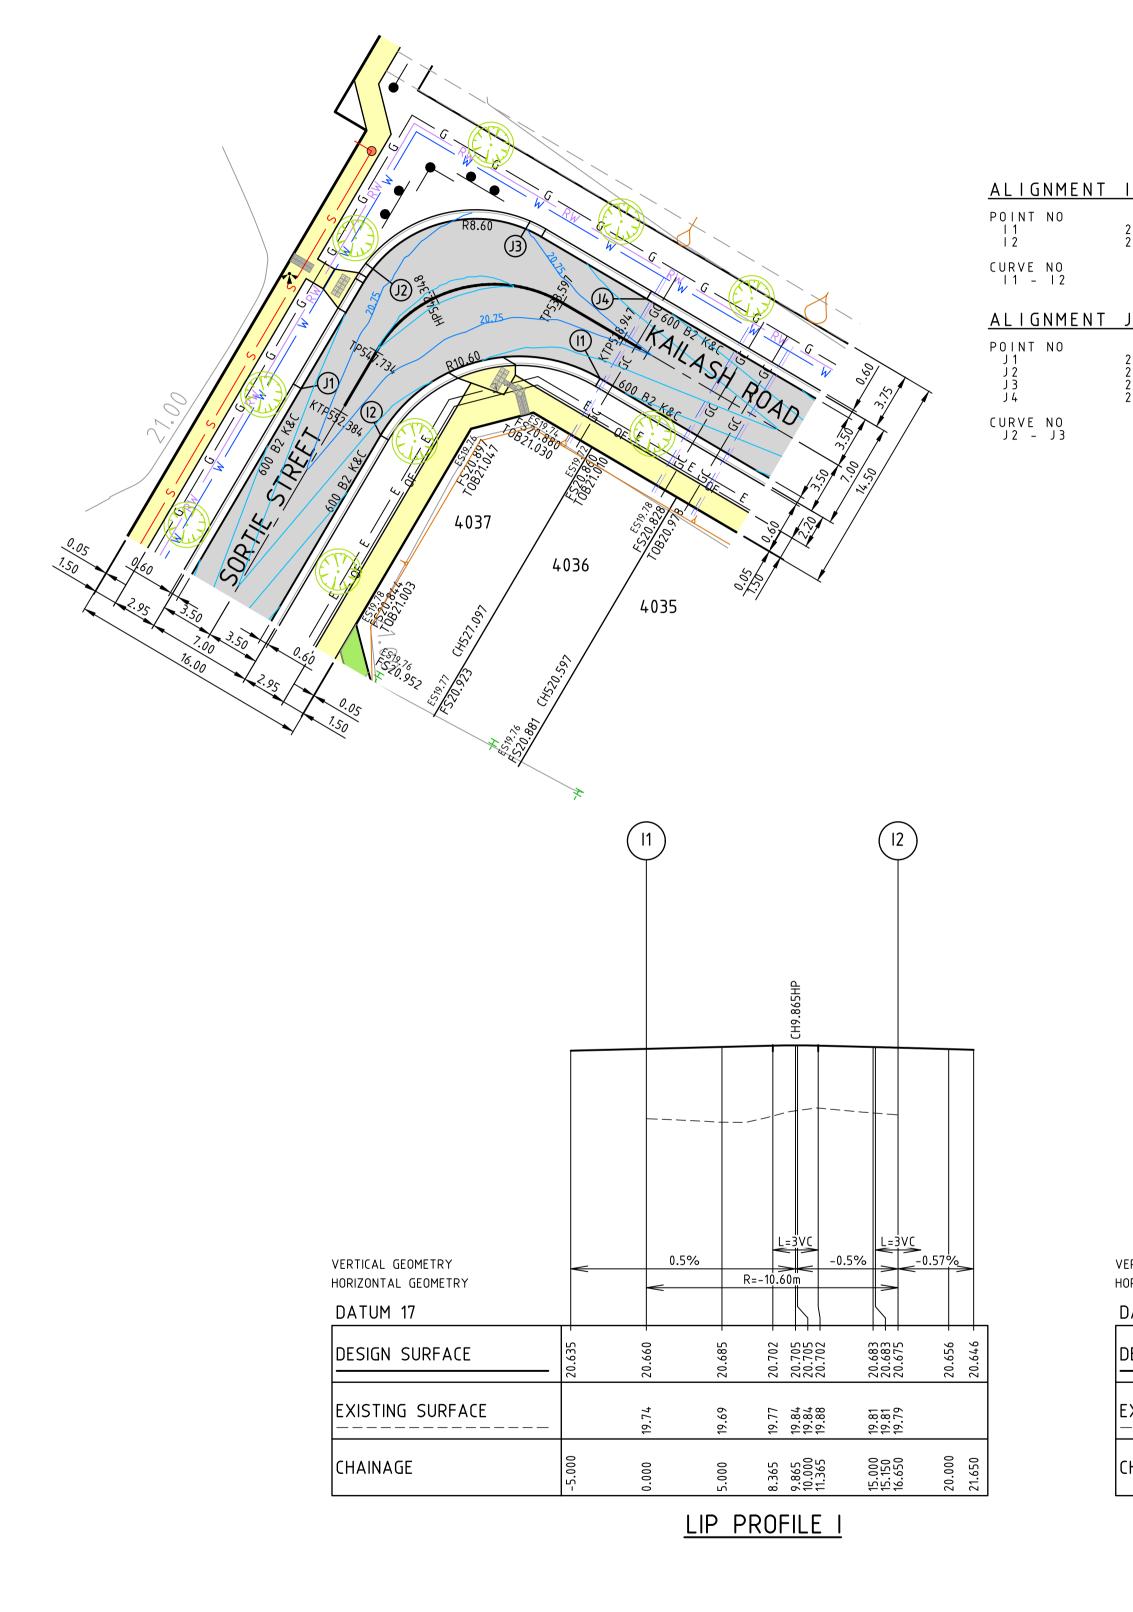
ABN 78 429 221 049

T +61 3 9813 7400

T +61 3 5246 1700

T +61 7 3374 9000

E info@dceng.com.au



_ 0.57%_ VERTICAL GEOMETRY R=7.40m HORIZONTAL GEOMETRY DATUM 17 20.707 20.685 20.670 20.661 20.660 DESIGN SURFACE 20.636 20.635 EXISTING SURFACE 19.82 19.82 19.82 19.82 19.82 25.000 27.017 28.517 30.000 30.017 CHAINAGE LIP PROFILE J

LIP SETOUT DETAIL

NOT TO SCALE

NOTE: END OF PAVEMENT WORKS CONCRETE EDGE STRIP AND AG DRAIN TO BE INSTALLED TO

THE END OF ALL PAVEMENT WORKS.

NOTE: EXISTING SERVICES

ALL EXISTING SERVICES UNDER NEW AND PROPOSED ROAD PAVEMENT, FOOTPATH AND DRIVEWAYS TO BE FCR BACKFILLED.

NOTE: EXISTING STRUCTURES ALL EXISTING DRAINAGE PITS AND SEWER STRUCTURES WITHIN NEW WORKS ARE TO BE ADJUSTED TO MATCH NEW FINISHED SURFACE LEVELS.

NOTE: TACTILE PAVING

TACTILE GROUND SURFACE INDICATORS (TGSI'S) ARE SHOWN INDICATIVELY AND SHOULD BE CONSTRUCTED IN ACCORDANCE WITH AS/NZS 1428.4.1:2009.

CAUTION!

ALL EXISTING SERVICES IN THE VICINITY OF WORKS SHALL BE PROTECTED AND KEPT IN FUNCTIONAL STATE AT ALL TIMES DURING WORKS.

BEWARE!

NBN OPTIC FIBRE CABLES IN THE VICINITY OF WORKS. TEL: 1800 687 626.

BEWARE!

TELSTRA OPTIC FIBRE CABLES IN THE VICINITY OF WORKS. TEL: 9253 8263.

BEWARE!

TELSTRA MAJOR CABLES ARE IN THE VICINITY OF WORKS.

BEWARE!

DEVELOPMENT VICTORIA FTTH OPTIC FIBRE CABLES IN THE VICINITY OF WORKS. TEL: 03 9311 4575.

WARNING!

NO DRAINAGE WORKS SHALL COMMENCE UNTIL THE CONTRACTOR CONFIRMS THE I.L. OF ALL EXISTING DRAINS, AND CONFIRMS IN WRITING WITH THE ENGINEERING SUPERVISOR.

DANGER!

OVERHEAD ELECTRICITY TRANSMISSION LINES. CONTRACTOR TO EXERCISE EXTREME CAUTION WHEN OPERATING IN THE VICINITY OF THESE LINES. THE CONTRACTOR MUST ADHERE TO ALL "NO GO ZONE" REQUIREMENTS OF THE POWER AUTHORITY.

WARNING!


THE LOCATION OF EXISTING SERVICES SHOWN ON THESE PLANS MUST BE PROVEN ON SITE, THE APPROPRIATE AUTHORITY MUST BE CONTACTED AND THE SERVICES LOCATED PRIOR TO COMMENCEMENT OF ANY WORKS.


WARNING!


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| | NOT TO BE USED FOR CONSTRUCTION | | | | Drawn Date AN | R.GUTIERREZ 14/09/22 3401095 |
|-------------|--|------------------|------------------|-------|------------------------|------------------------------------|
| | | | | | Designed Date AN | P.NICHOLSON 13/09/22 3791018 |
| D | COUNCIL COMMENTS 29/11/22 | 30/11/22 | PN/SR | TL | Checked | S.RAJKOVIC |
| С | COUNCIL COMMENTS 24/10/22 | 17/11/22 | GA | TL | Date | 21/09/22 |
| В | COUNCIL ISSUE | 21/09/22 | PN/RG | TL | Annroyed | 2951057 |
| Α | TENDER ISSUE | 14/09/22 | PN/NR | TL | Approved Date | |
| REV | DESCRIPTION | DATE | AMEND | APP'D | AN | |
| /ritten dir | mensions to take precedence over scale. Contractor shall check and verify all dimensions on site. Discrepancies to be brought to | the attention of | the Superintende | ent. | © Dalton Cons | ulting Engineers Pty Ltd |

| R.GUTIERREZ 14/09/22 3401095 | _ |
|------------------------------------|---------|
| P.NICHOLSON 13/09/22 3791018 | H- |
| S.RAJKOVIC 21/09/22 2951057 | F T(|
| | —Е; |



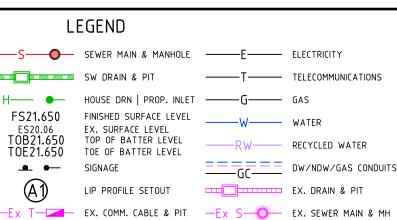

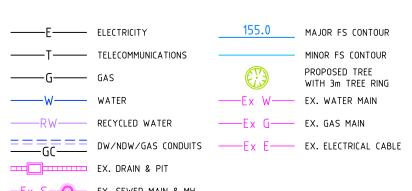

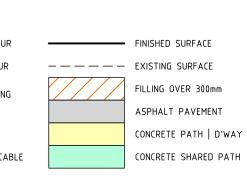RADIUS 10.600

NORTHING 5801636.758 5801644.773 5801647.375 5801642.679

3.105

2.182

2.298 4.056

1.615 2.841 2.406

90.000

EASTING 293122.520 293127.237 293137.404 293145.383

l 90.321





Scale @ A1/A3 H1:250/500 V1:50/100

RIVERWALK STAGE 40 **GEELONG ROAD, WERRIBEE** WYNDHAM CITY COUNCIL **INTERSECTION DETAILS SHEET 04 OF 05** Drawing No. 10940ID04 Rev D

Sheet No. 10 of 40



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-0.5%

DATE AMEND APP'D AN

0.5%

R = -8.60 m

LIP PROFILE N

© Dalton Consulting Engineers Pty Ltd


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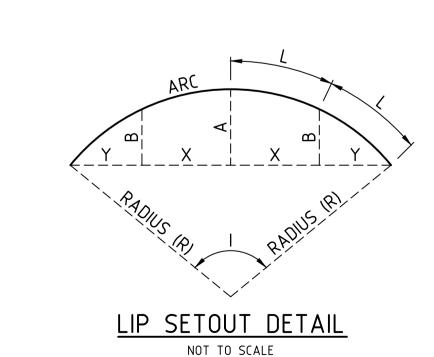
14.899 15.000 15.151 17.809 20.000

98 96 96 95

19. 19.

<u>ALIGNMENT N</u> NORTHING POINT NO 5801644.742 5801645.756 5801643.841 CURVE NO N1 - N2 MID POINT RL 19.948 ARC 15.151 100.943 3.126 2.306 3.667 2.967 3.788 <u>ALIGNMENT O</u> EASTING 293258.792 293262.424 293262.373 POINT NO 5 8 0 1 6 4 8 . 0 7 1 5 8 0 1 6 5 1 . 8 4 5 19.970 19.980 20.036 5801663.826 CURVE NO 02 - 03 MID POINT RL 88.308 8.600 13.255 2.430 1.799 3.232 2.758



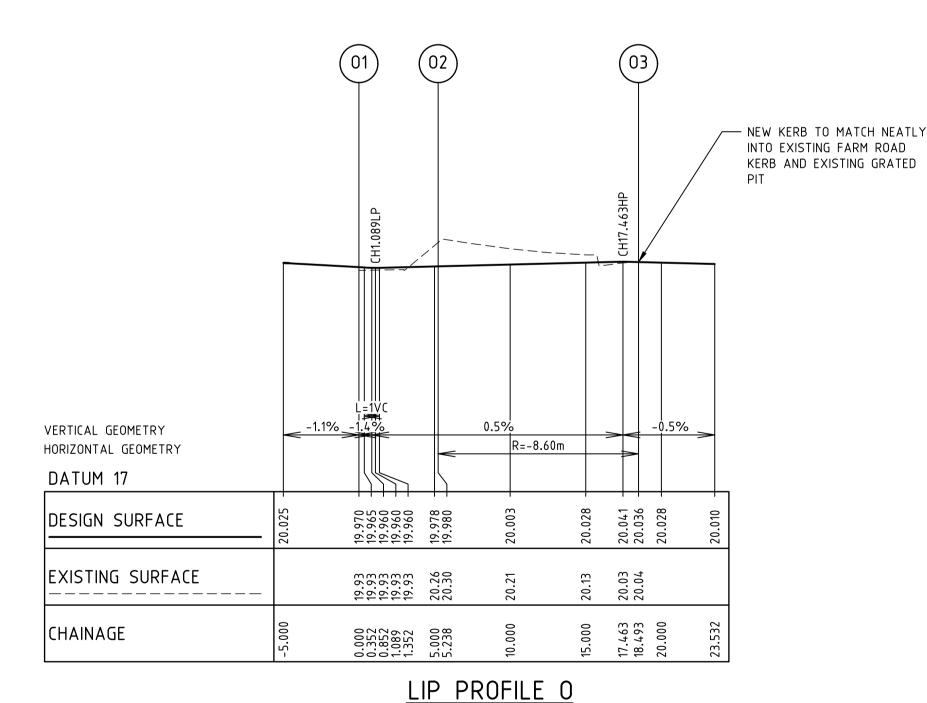

NOTE: END OF PAVEMENT WORKS CONCRETE EDGE STRIP AND AG DRAIN TO BE INSTALLED TO

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| | NOT TO BE USED FOR CONSTRUCTION | | | | Drawn Date AN | R.GUTIERRE 14/09/22 3401095 |
|---|---------------------------------|----------|-------|----|------------------------|-----------------------------------|
| | | | | | Designed Date AN | P.NICHOLSO 13/09/22 3791018 |
| D | COUNCIL COMMENTS 29/11/22 | 30/11/22 | PN/SR | TL | Checked | S.RAJKOVIC |
| С | COUNCIL COMMENTS 24/10/22 | 17/11/22 | GA | TL | Date | 21/09/22 |
| В | COUNCIL ISSUE | 21/09/22 | PN/RG | TL | Annroyad | 2951057 |
| Α | TENDER ISSUE | 14/09/22 | PN/NR | TL | Approved Date | |

Written dimensions to take precedence over scale. Contractor shall check and verify all dimensions on site. Discrepancies to be brought to the attention of the Superintendent.

VERTICAL GEOMETRY


DATUM 17


CHAINAGE


HORIZONTAL GEOMETRY

DESIGN SURFACE

EXISTING SURFACE

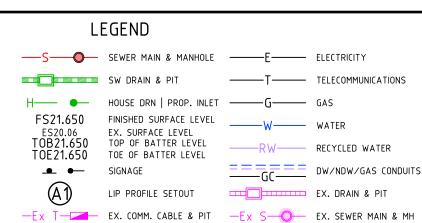

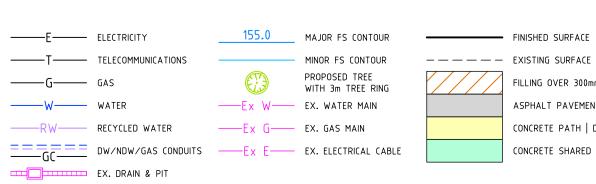

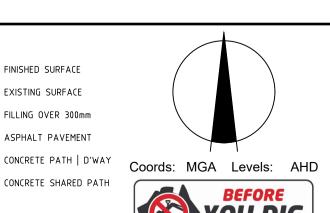




Scale @ A1/A3 H1:250/500 V1:50/100

RIVERWALK STAGE 40 **GEELONG ROAD, WERRIBEE** WYNDHAM CITY COUNCIL **INTERSECTION DETAILS SHEET 05 OF 05** Drawing No. 10940ID05 Rev D

Sheet No. 11 of 40



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D | COUNCIL COMMENTS 29/11/22 30/11/22 PN/SR TL C COUNCIL COMMENTS 24/10/22 17/11/22 GA B | COUNCIL ISSUE 21/09/22 PN/RG 14/09/22 PN/NR TL Date A TENDER ISSUE DATE AMEND APP'D AN REV DESCRIPTION

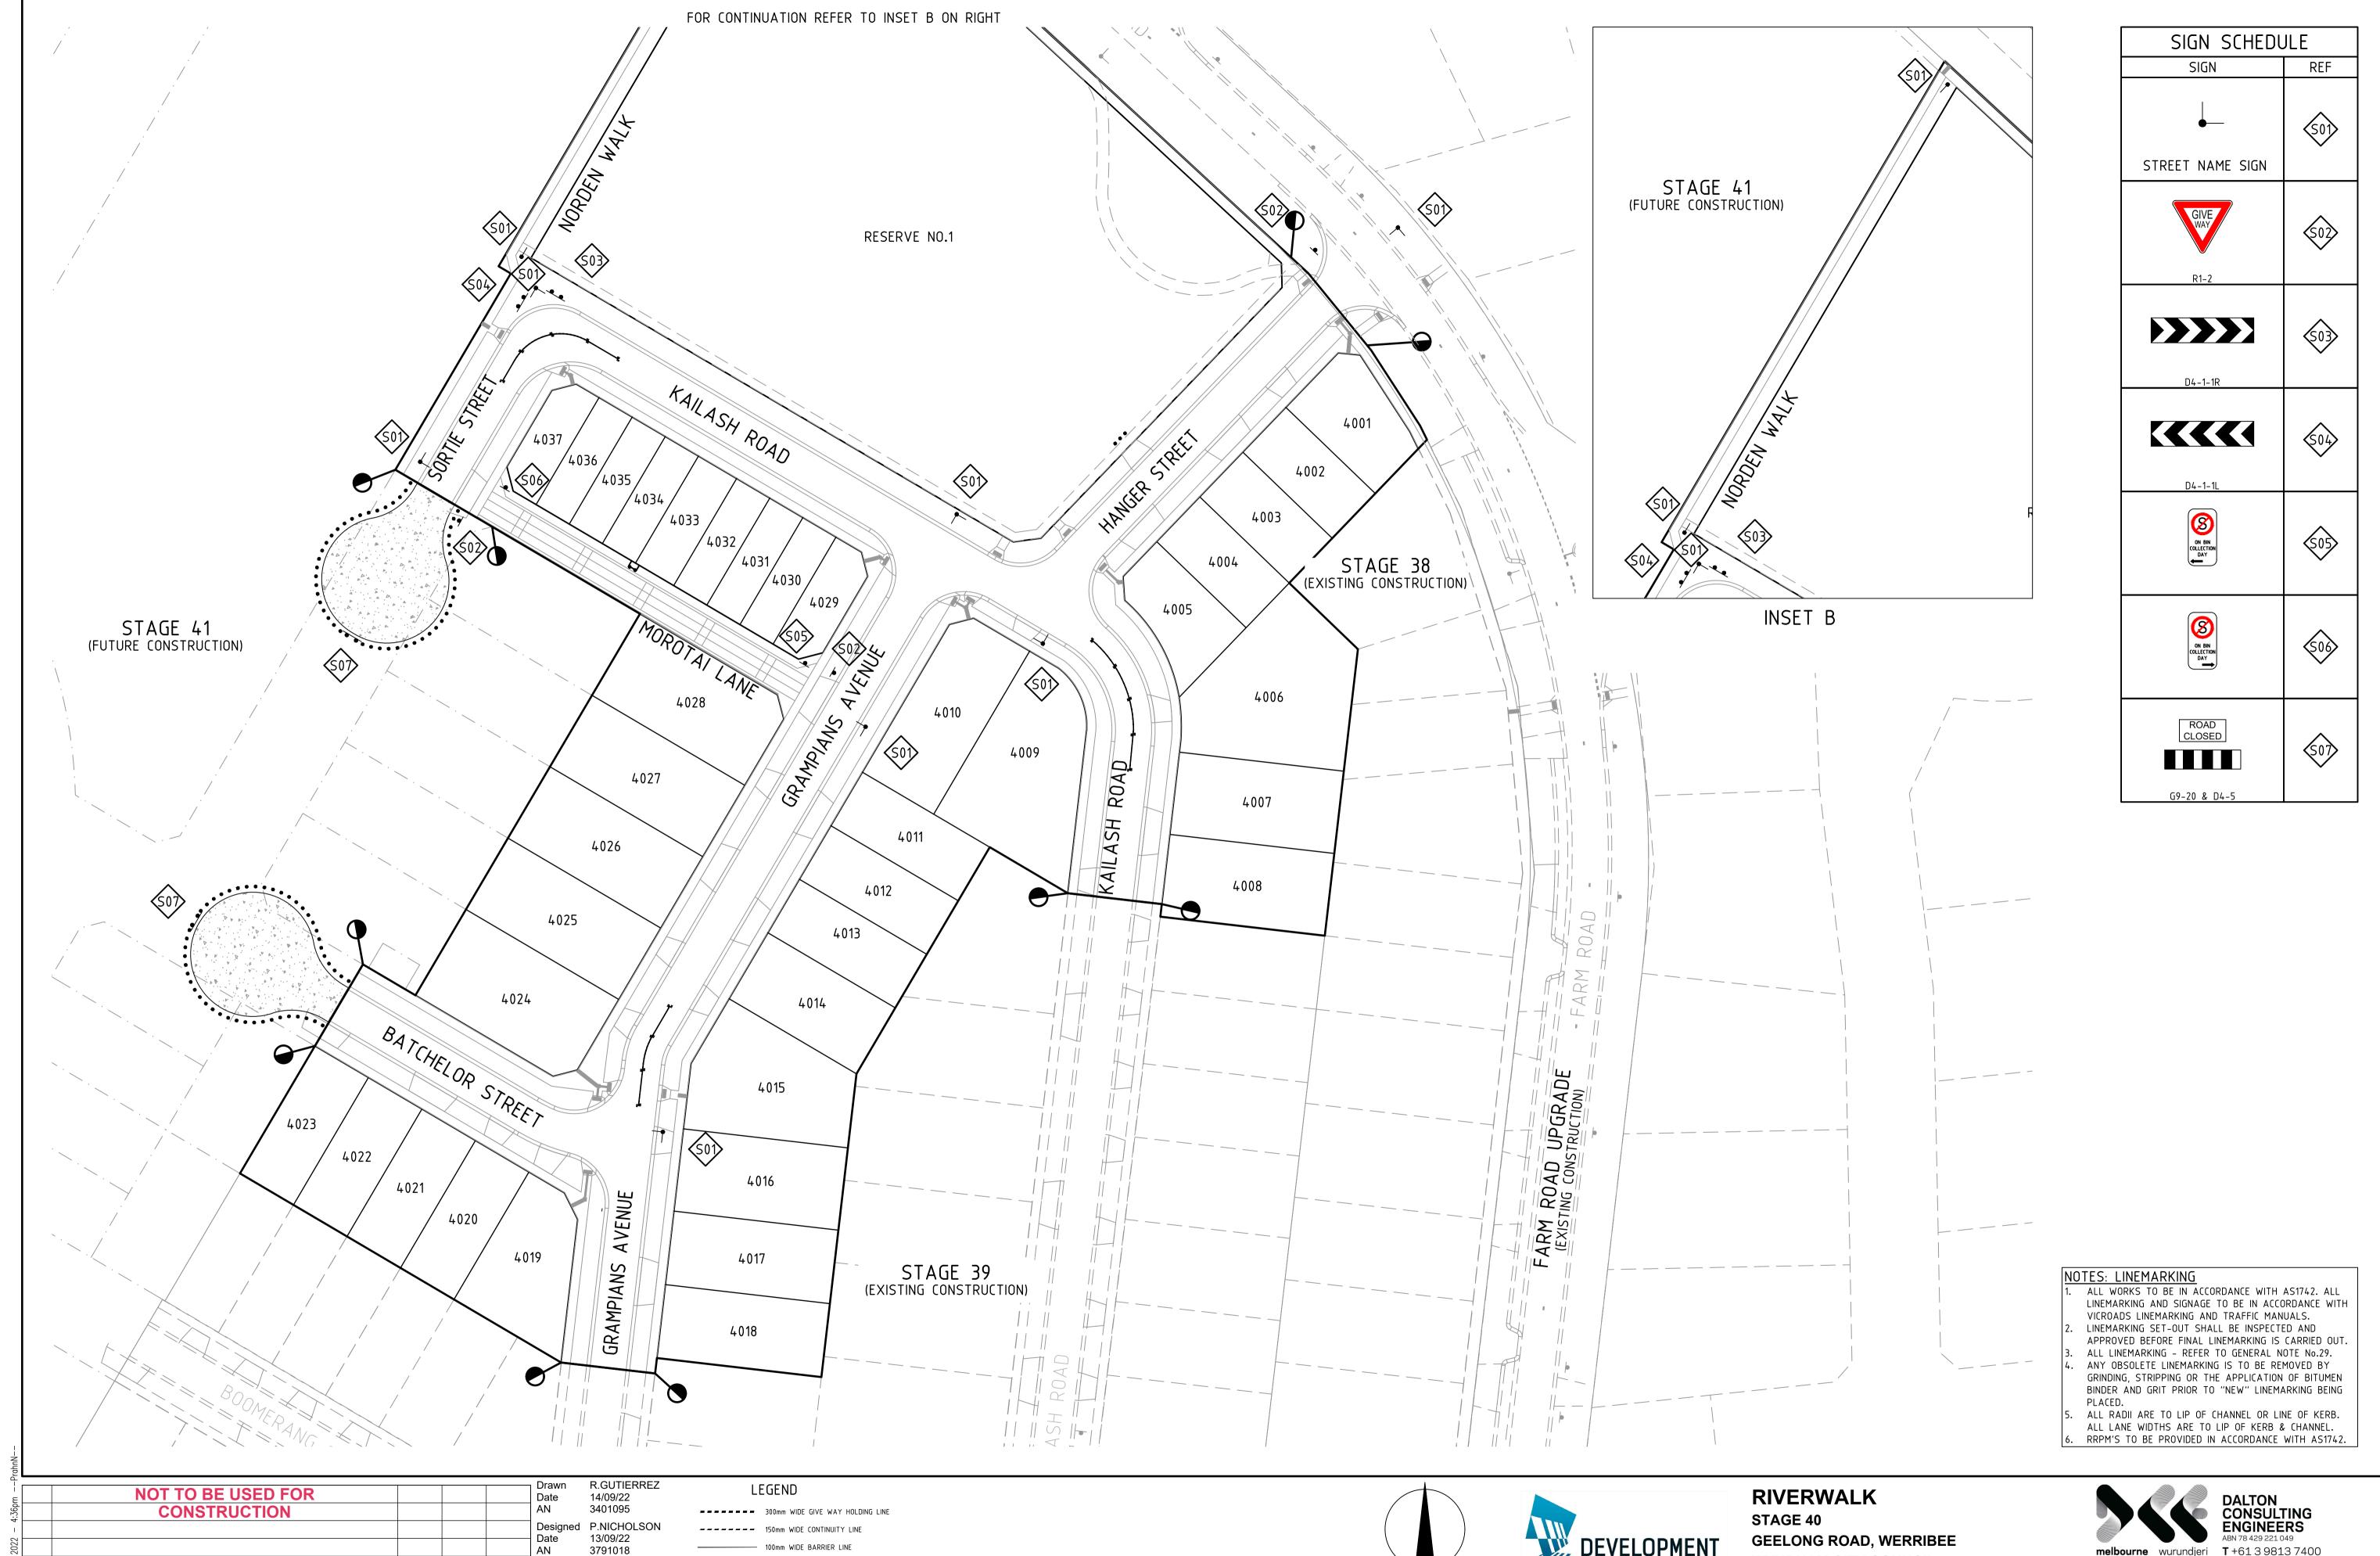Written dimensions to take precedence over scale. Contractor shall check and verify all dimensions on site. Discrepancies to be brought to the attention of the Superintendent.

RRPM'S (SPACED AT 6m c/c UNLESS NOTED OTHERWISE) DENOTES TACTILE GROUND INDICATORS IN ACCORDANCE WITH AS. 1428

STREET NAME SIGNAGE

OTHER SIGNAGE

Checked S.RAJKOVIC

21/09/22

Date





Scale @ A1/A3

1:500 / 1:1000

WYNDHAM CITY COUNCIL SIGNAGE AND LINEMARKING PLAN

Drawing No. 10940LM01 Rev D Sheet No. 12 of 40




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NOTE: ALL OTHER FILL FILLING COMPACTED TO AS3798-2007 LEVEL 1 REQUIREMENTS WITH APPROVED FILL MATERIAL



LONGITUDINAL SECTION KAILASH ROAD / SORTIE STREET DESIGN LINE

| GY-MEL\ nPro | | NOT TO BE USED FOR | | | | Drawn R.GUTIERF Date 14/09/22 | REZ LEGEND |
|---|-----|---|--------------------|------------------|-------|----------------------------------|----------------------------------|
| SYNERGY. | | CONSTRUCTION | | | | AN 3401095 | —————— EXISTING SURFACE |
| rto/ | | | | | | Designed P.NICHOLS Date 13/09/22 | FINISHED SURFACE |
| .gy\dc 2022 | | | | | | AN 3791018 | FIN. SUR, (FUTURE STG.) |
| Syner 31 30, | D | COUNCIL COMMENTS 29/11/22 | 30/11/22 | PN/SR | TL | Checked S.RAJKOVI | IC — — FIN. SUR, (PREVIOUS STG.) |
| 12d - LS(Nov | ١ ^ | COUNCIL COMMENTS 24/10/22 | 17/11/22 | GA | TL | Date 21/09/22 AN 2951057 | BEW SURFACE |
| C:\ ed | В | COUNCIL ISSUE | 21/09/22 | PN/RG | TL | | LEFT LIP OF KERB |
| Drawing File: 10940LS01.dv Date/Time: W | Α | TENDER ISSUE | 14/09/22 | PN/NR | TL | Approved Date | |
| rawing 3940L ate/T | REV | DESCRIPTION | DATE | AMEND | APP'D | AN | |
| 7 5 9 9 6 9 | | mensions to take precedence over scale. Contractor shall check and verify all dimensions on site. Discrepancies to be brought t | o the attention of | the Superintende | ent. | © Dalton Consulting Engineers F | Pty Ltd |

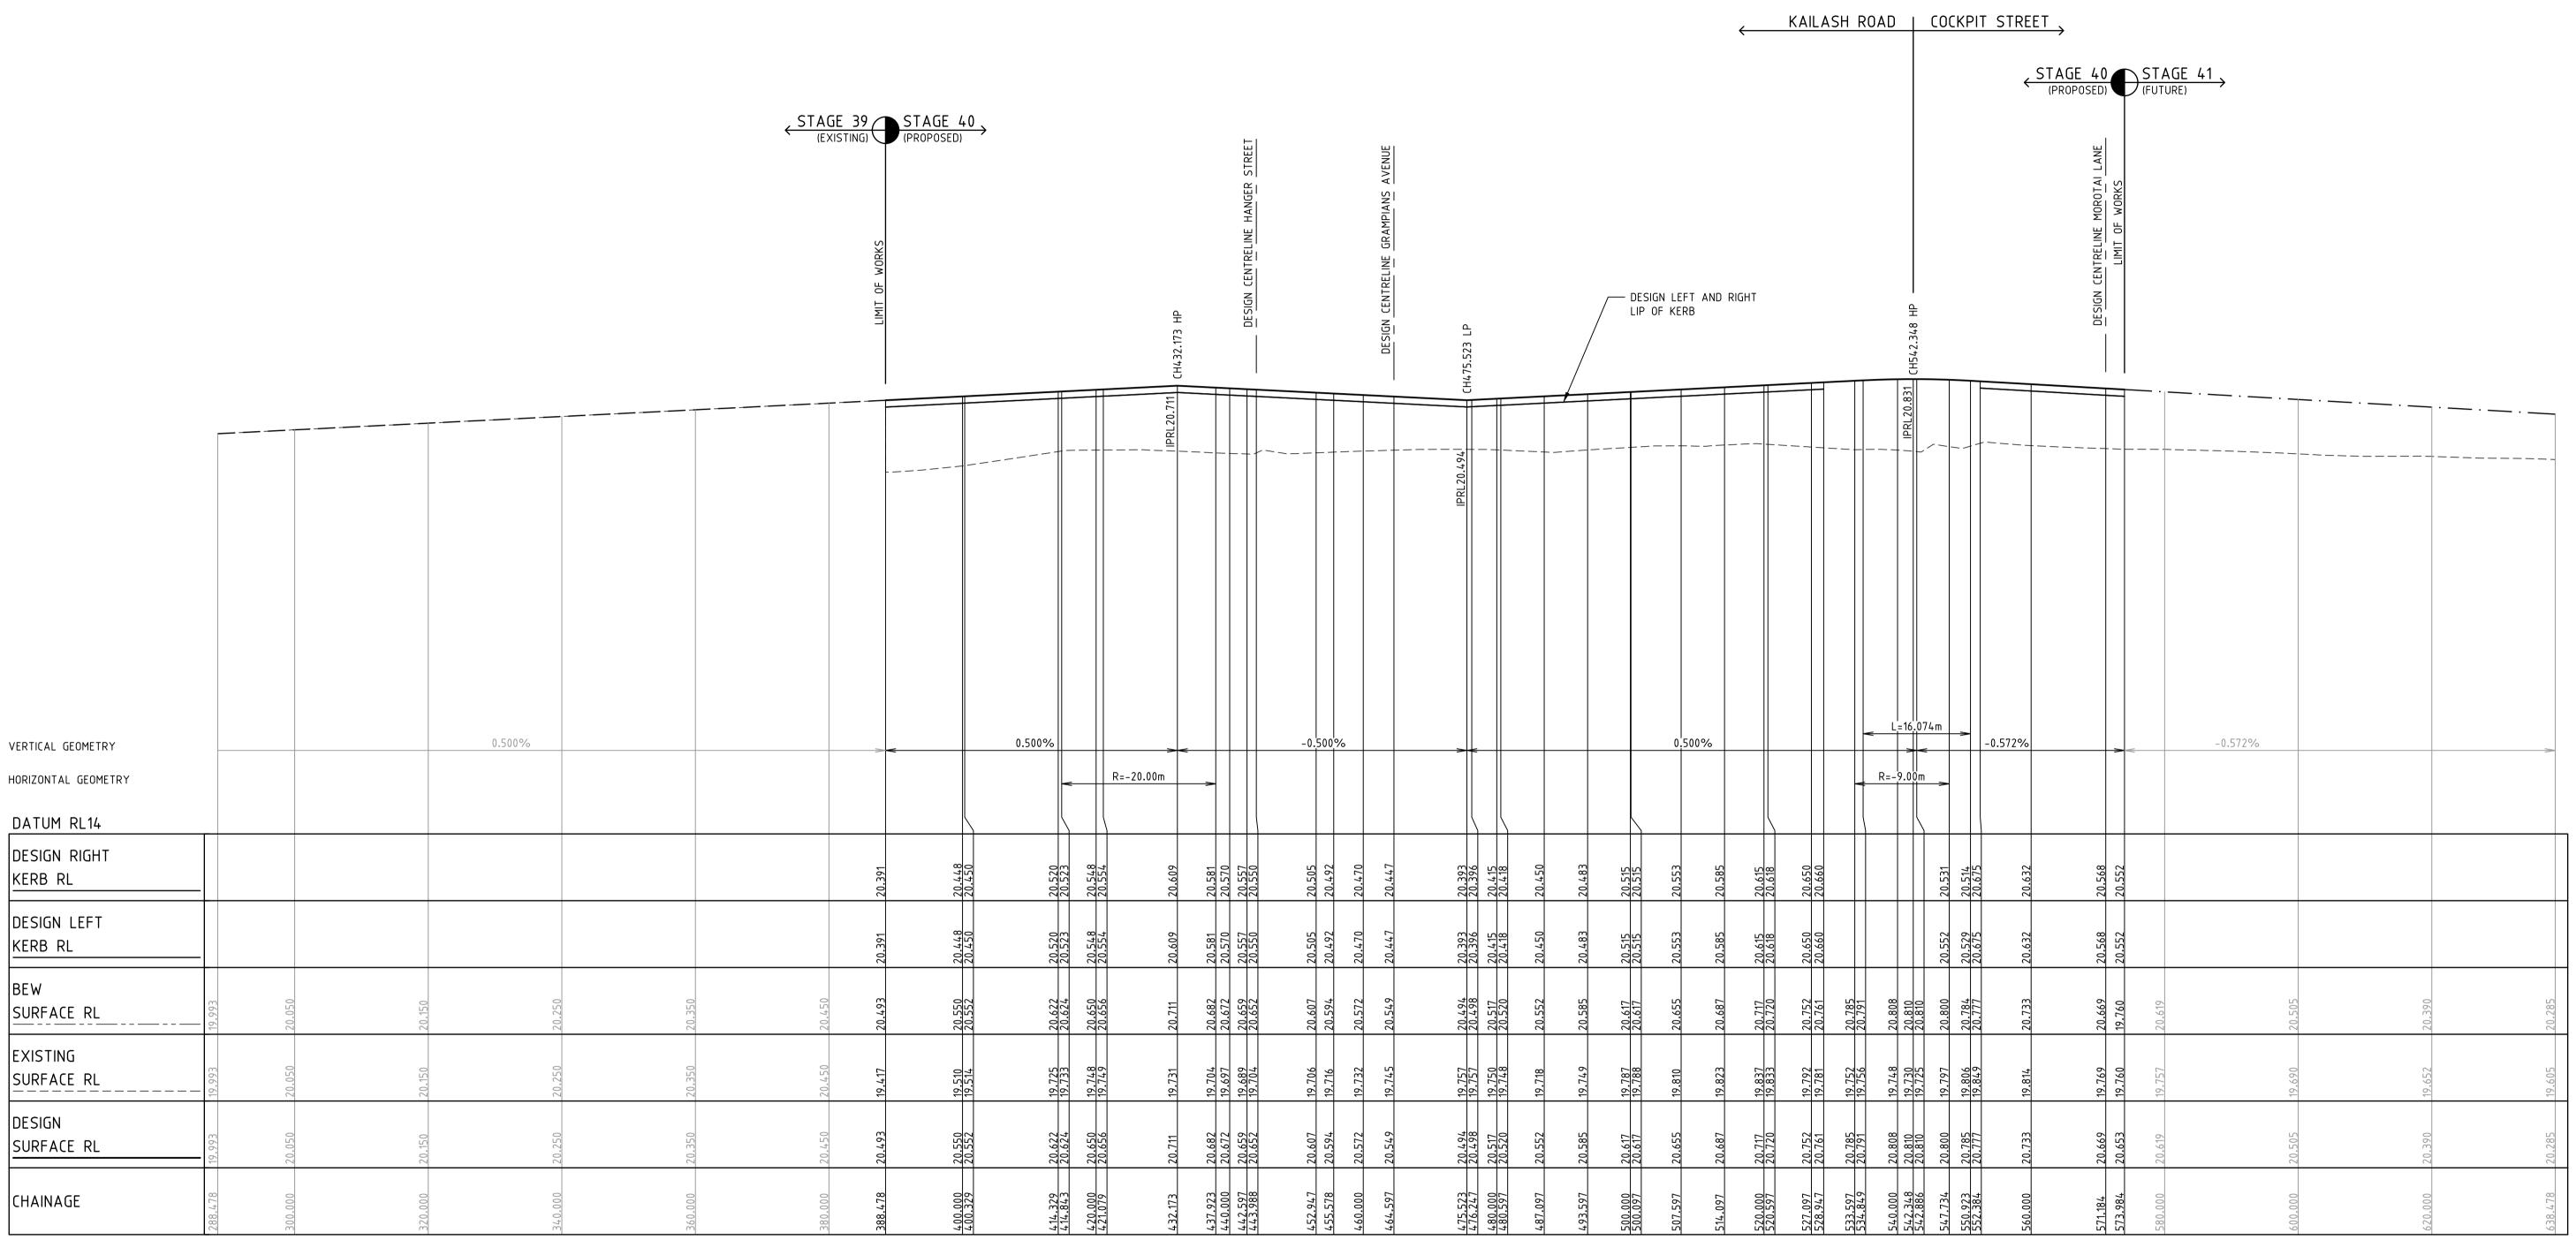

Scale @ A1/A3 H1:500/1000 V1:50/100

RIVERWALK STAGE 40 **GEELONG ROAD, WERRIBEE** WYNDHAM CITY COUNCIL **ROAD LONGITUDINAL SECTIONS SHEET 01 OF 04** Drawing No. 10940LS01 Rev D

Sheet No. 13 of 40




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NOTE: ALL OTHER FILL FILLING COMPACTED TO AS3798-2007 LEVEL 1 REQUIREMENTS WITH APPROVED FILL MATERIAL



LONGITUDINAL SECTION GRAMPIANS AVENUE DESIGN LINE

| | NOT TO BE USED FOR | | | | | GUTIERREZ 09/22 | LEGEND |
|-----|---------------------------|----------|-------|-------|---------------|--------------------|--------------------------|
| | CONSTRUCTION | | | | AN 340 | 1095 | — — — — EXISTING SURFACE |
| | | | | | | IICHOLSON 09/22 | |
| | | | | | |)1018 | FIN. SUR, (FUTURE STO |
| D | COUNCIL COMMENTS 29/11/22 | 30/11/22 | PN/SR | TL | Checked S.R | AJKOVIC | FIN. SUR, (PREVIOUS S |
| С | COUNCIL COMMENTS 24/10/22 | 17/11/22 | GA | TL | | 09/22 | BEW SURFACE |
| В | COUNCIL ISSUE | 21/09/22 | PN/RG | TL | | 51057 | LEFT LIP OF KERB |
| Α | TENDER ISSUE | 14/09/22 | PN/NR | TL | Approved Date | | |
| REV | DESCRIPTION | DATE | AMEND | APP'D | AN | | |

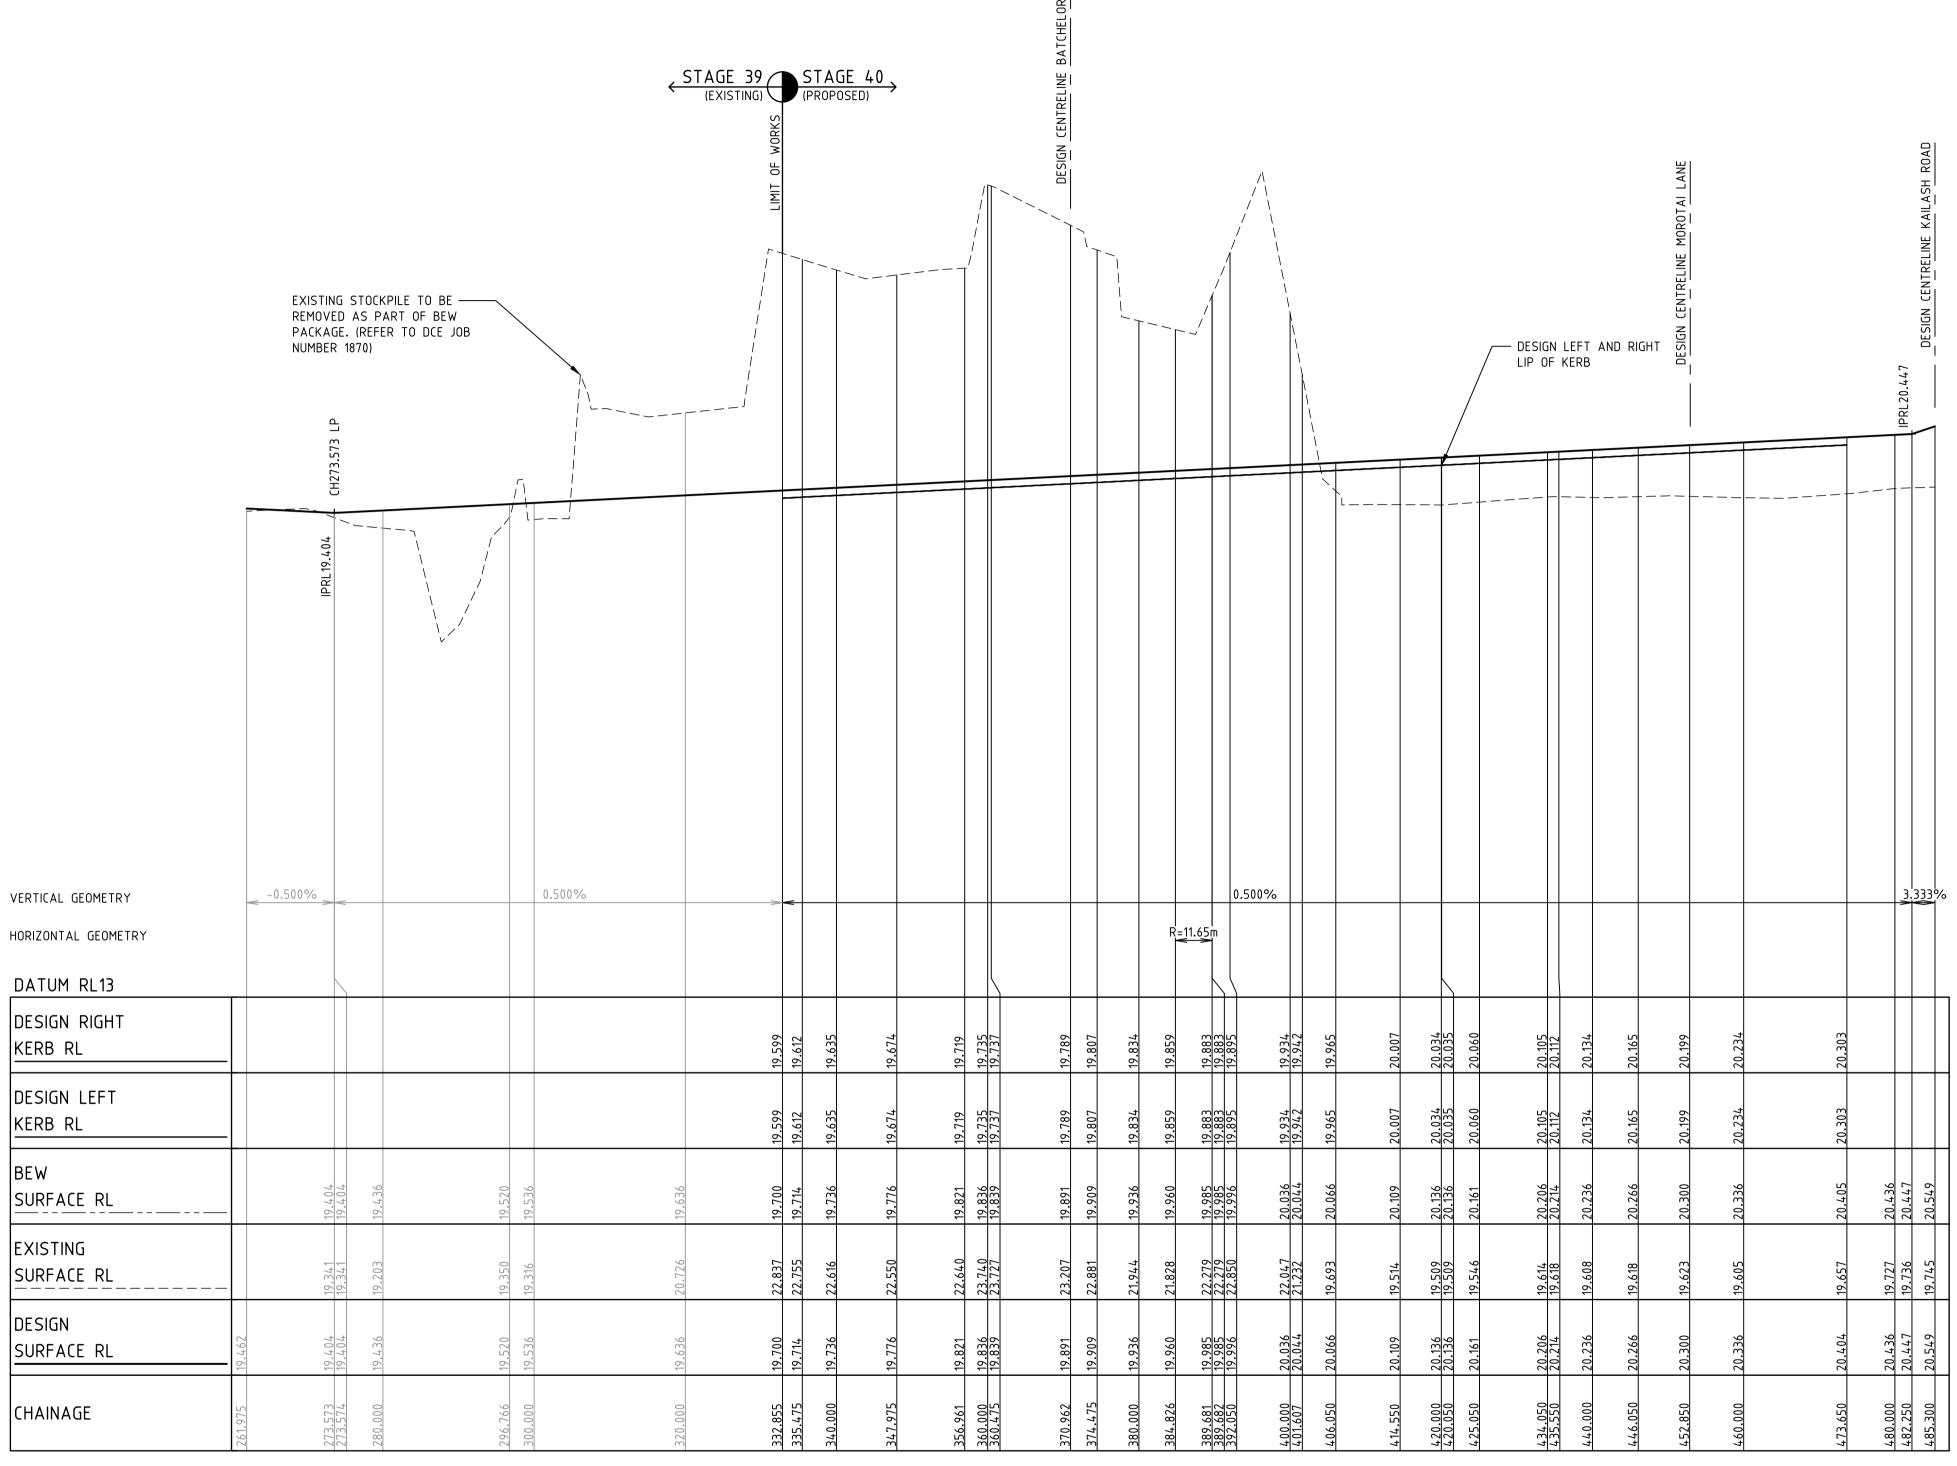

Scale @ A1/A3 H1:500/1000 V1:50/100

RIVERWALK STAGE 40 **GEELONG ROAD, WERRIBEE** WYNDHAM CITY COUNCIL **ROAD LONGITUDINAL SECTIONS SHEET 02 OF 04**

Drawing No. 10940LS02 Rev D Sheet No. 14 of 40




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E info@dceng.com.au



NOTE: ALL OTHER FILL FILLING COMPACTED TO AS3798-2007 LEVEL 1 REQUIREMENTS WITH APPROVED FILL MATERIAL

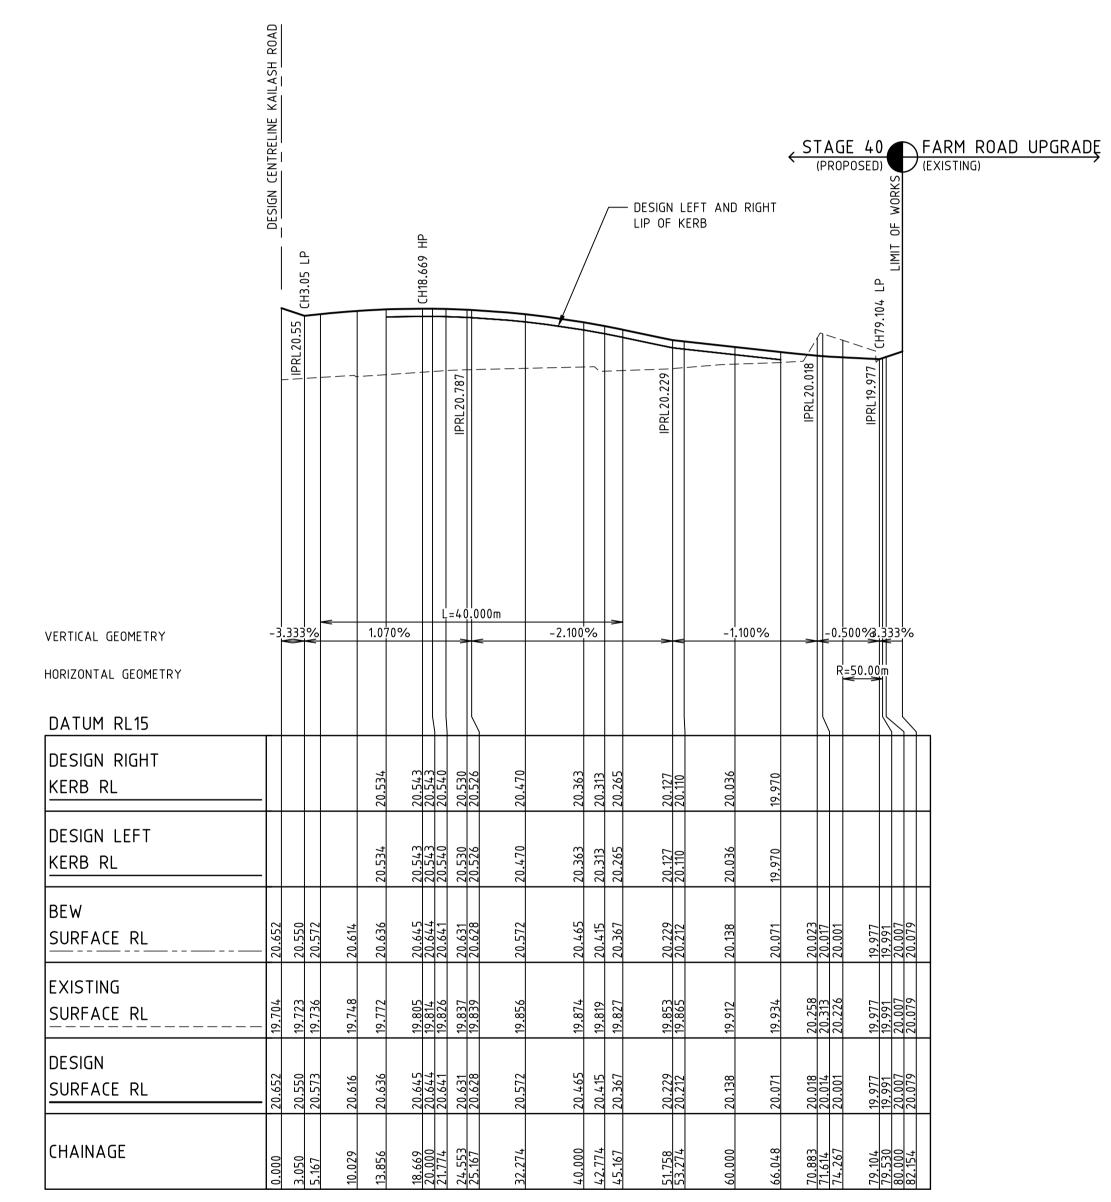

LONGITUDINAL SECTION HANGER STREET DESIGN LINE

| | DESIGN CENTRELINE GRAMPIANS AVENUE | CH3.5 LP CH3 57, HB | 13.65 LP | | | | | | | | <i>y</i> | / | / | — DESIGN LIP OF | LEFT | AN | D RI | ☐HT | | | CH/4.5 LP DESIGN CENTRELINE SORTIE STREET | |
|--|------------------------------------|-------------------------------------|------------------|--------|----------|--------|--------|--------|----------|--------|----------|--------|----------|--------------------|----------|--------|--------|--------|------------------|--------|---|----------------------------|
| VERTICAL GEOMETRY HORIZONTAL GEOMETRY | | 3.0.0 -0.0.0 -8.888 375.00 | | 00% | /6 | | | | | | .64 | 7% | | | | | | -0.5 | | | 3.333 3.333 3.43 3.529 3.43 | 3% % % |
| DATUM RL15 DESIGN RIGHT KERB RL | | | | | 20.432 | 20.574 | 20 599 | 20.616 | 20.658 | 20.700 | 20.716 | 20.729 | 20.748 | 20.790 | 20.832 | 20.858 | 20.874 | 20.879 | | | | |
| DESIGN LEFT KERB RL | _ | | | | 20.432 2 | 20.574 | 20 599 | | 20.658 2 | 20.700 | | | 20.748 2 | 20.790 2 | 20.832 2 | | | 20.879 | | | | |
| BEW SURFACE RL | _ | 20.199 | 20.309 | 20.309 | 20.432 | 20.484 | 20 510 | 20.526 | 20.568 | 20.610 | 20.627 | 20.640 | 20.659 | 20.701 | 20.743 | 20 769 | 20.785 | 20.821 | 20.801 | 20.678 | 20.678 20.578 | 20.568 20.568 20.670 |
| EXISTING SURFACE RL | _ | 19.616 | 19.615 19.615 | 19.615 | 19.607 | 19.631 | 19 608 | 19.583 | 19.604 | 19.662 | 19.684 | 19.694 | 19.700 | 19.711 | 19.727 | 19 733 | 19.737 | 19.741 | 19.742 | | | 19.758 19.769 |
| DESIGN SURFACE RL | 1 20.301 | 20.199 | 20.309 | 20.309 | 20.432 | 20.484 | 20 510 | 20.526 | 20.568 | 20.610 | 20.627 | 20.640 | 20.659 | 20.701 | 20.743 | 99 169 | 20.785 | 20.821 | 20.801 | 20.678 | 20.678 20.578 | 20.568 20.670 |
| CHAINAGE | 0.000 | 3.050 | 3.540 3.540 | 3.650 | 7.950 | 16.000 | 20 000 | 22.500 | 29.000 | 35.500 | 38.000 | 000.04 | 43.000 | 79.500 | 56.000 | 000 09 | 62.500 | 68.050 | 70.050 71.550 | 74.350 | 74.460 | 74.950 74.950 78.000 |


LONGITUDINAL SECTION MOROTAI LANE DESIGN LINE

| | | | | | ı Drawn | R.GUTIERREZ | | E C E N I D |
|-----|---------------------------|----------|-------|-------|---------------|---------------------|---|---------------------------|
| | NOT TO BE USED FOR | | | | Date | 14/09/22 | L | EGEND |
| | CONSTRUCTION | | | | AN | 3401095 | | EXISTING SURFACE |
| | | | | | Designed | P.NICHOLSON | | FINISHED SURFACE |
| | | | | | Date AN | 13/09/22 3791018 | · | FIN. SUR, (FUTURE STG.) |
| D | COUNCIL COMMENTS 29/11/22 | 30/11/22 | PN/SR | TL | Checked | S.RAJKOVIC | | FIN. SUR, (PREVIOUS STG.) |
| С | COUNCIL COMMENTS 24/10/22 | 17/11/22 | GA | TL | Date | 21/09/22 | | BEW SURFACE |
| В | COUNCIL ISSUE | 21/09/22 | PN/RG | TL | AN | 2951057 | | LEFT LIP OF KERB |
| Α | TENDER ISSUE | 14/09/22 | PN/NR | TL | Approved Date | | | RIGHT LIP OF KERB |
| REV | DESCRIPTION | DATE | AMEND | APP'D | AN | | | |

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Scale @ A1/A3 H1:500/1000 V1:50/100




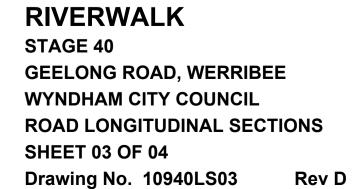

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brisbane turrbal
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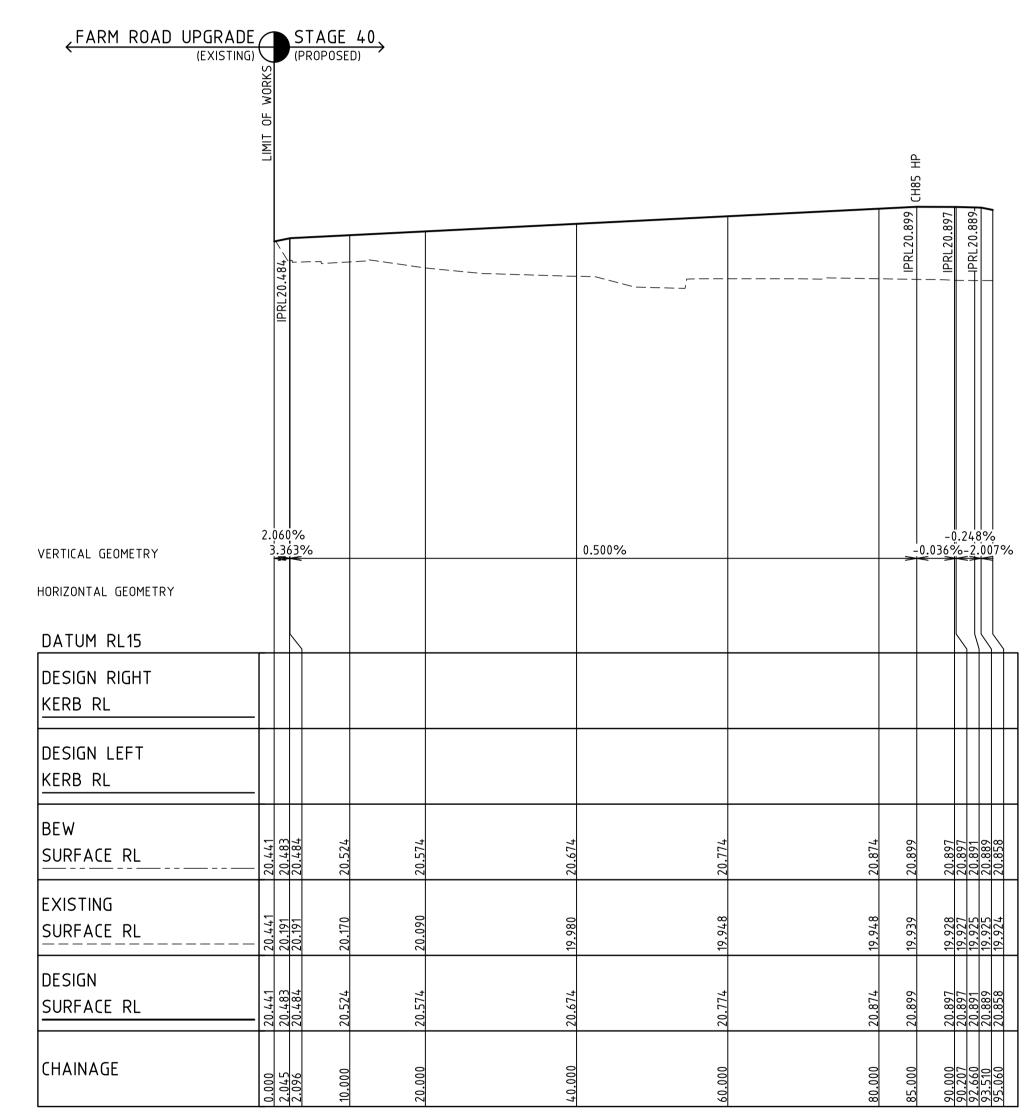
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E info@dceng.com.au

NOTE: ALL OTHER FILL FILLING COMPACTED TO AS3798-2007 LEVEL 1 REQUIREMENTS WITH APPROVED FILL MATERIAL

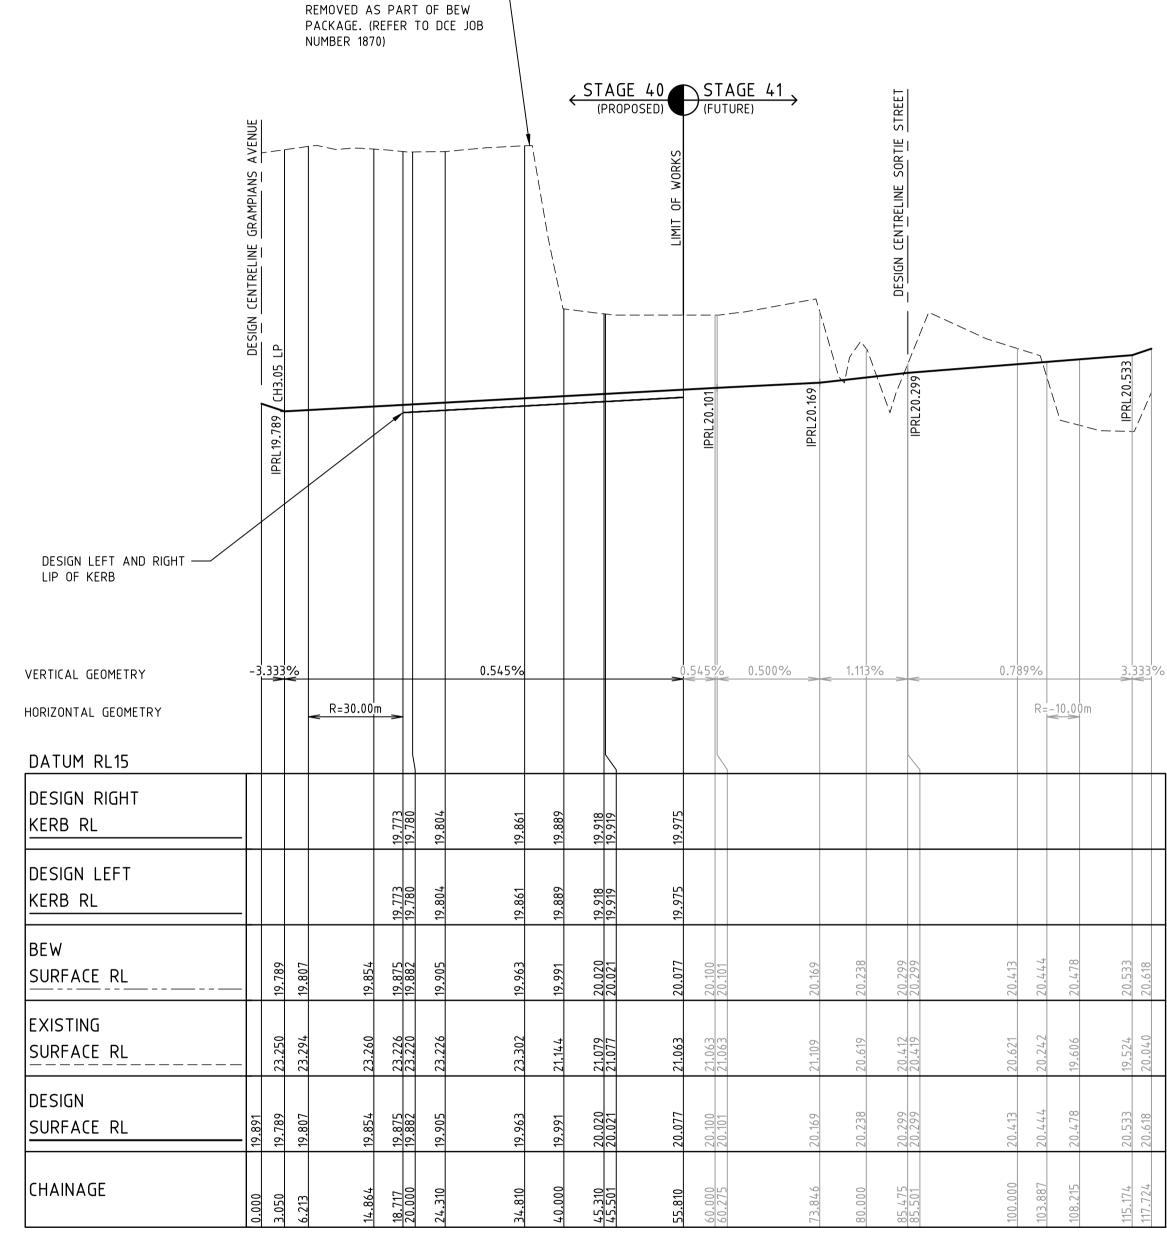

EXISTING STOCKPILE TO BE —

LONGITUDINAL SECTION BATCHELOR STREET DESIGN LINE



LONGITUDINAL SECTION NORDEN WALK DESIGN LINE

| Y-MEI | | NOT TO BE USED FOR | | | | Drawn Date | R.GUTIERREZ 14/09/22 | LEGEND |
|---|------------|--|------------------|------------------|-------|------------------|--------------------------|---------------------------|
| SYNERGY | | CONSTRUCTION | | | | AN | 3401095 | ————— EXISTING SURFACE |
| ,data\S 22 - 4 | | | | | | Designed Date | P.NICHOLSON 13/09/22 | |
| rgy\d | | | | | | AN | 3791018 | FIN. SUR, (FUTURE STG.) |
| Syne 34 30, | D | COUNCIL COMMENTS 29/11/22 | 30/11/22 | PN/SR | TL | Checked | S.RAJKOVIC | FIN. SUR, (PREVIOUS STG.) |
| ,12d Syr - LS04 Nov 30, | С | COUNCIL COMMENTS 24/10/22 | 17/11/22 | GA | TL | Date AN | 21/09/22 2951057 | BEW SURFACE |
| | В | COUNCIL ISSUE | 21/09/22 | PN/RG | TL | | 2931037 | LEFT LIP OF KERB |
| Drawing File: C: 10940LS01.dwg Date/Time: Wed | Α | TENDER ISSUE | 14/09/22 | PN/NR | TL | Approved Date | | |
| rawing 3940L ate/Ti | REV | DESCRIPTION | DATE | AMEND | APP'D | AN | | |
| 주6명, | Written di | mensions to take precedence over scale. Contractor shall check and verify all dimensions on site. Discrepancies to be brought to | the attention of | the Superintende | ent. | © Dalton Cons | ulting Engineers Pty Ltd | |



Scale @ A1/A3 H1:500/1000 V1:50/100

RIVERWALK STAGE 40 GEELONG ROAD, WERRIBEE WYNDHAM CITY COUNCIL **ROAD LONGITUDINAL SECTIONS SHEET 04 OF 04** Drawing No. 10940LS04 Rev D



DALTON CONSULTING ENGINEERS geelong wadawurrung brisbane turrbal dceng.com.au T+61 3 5246 1700 T+61 7 3374 9000 E info@dceng.com.au



Written dimensions to take precedence over scale. Contractor shall check and verify all dimensions on site. Discrepancies to be brought to the attention of the Superintendent.

POINT TYPE


STRAIGHT


CONSTRUCTION D COUNCIL COMMENTS 29/11/22 |30/11/22| PN/SR | TL C COUNCIL COMMENTS 24/10/22 17/11/22 GA B | COUNCIL ISSUE 21/09/22 PN/RG 14/09/22 PN/NR A TENDER ISSUE REV DESCRIPTION


NOT TO BE USED FOR


14/09/22 3401095 Designed P.NICHOLSON 13/09/22 3791018 S.RAJKOVIC Checked 21/09/22 2951057

Date

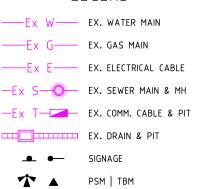

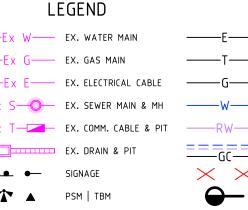

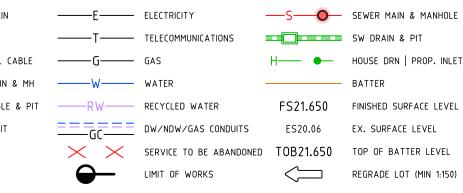

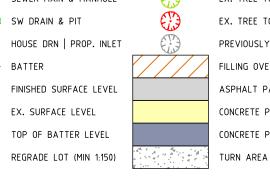





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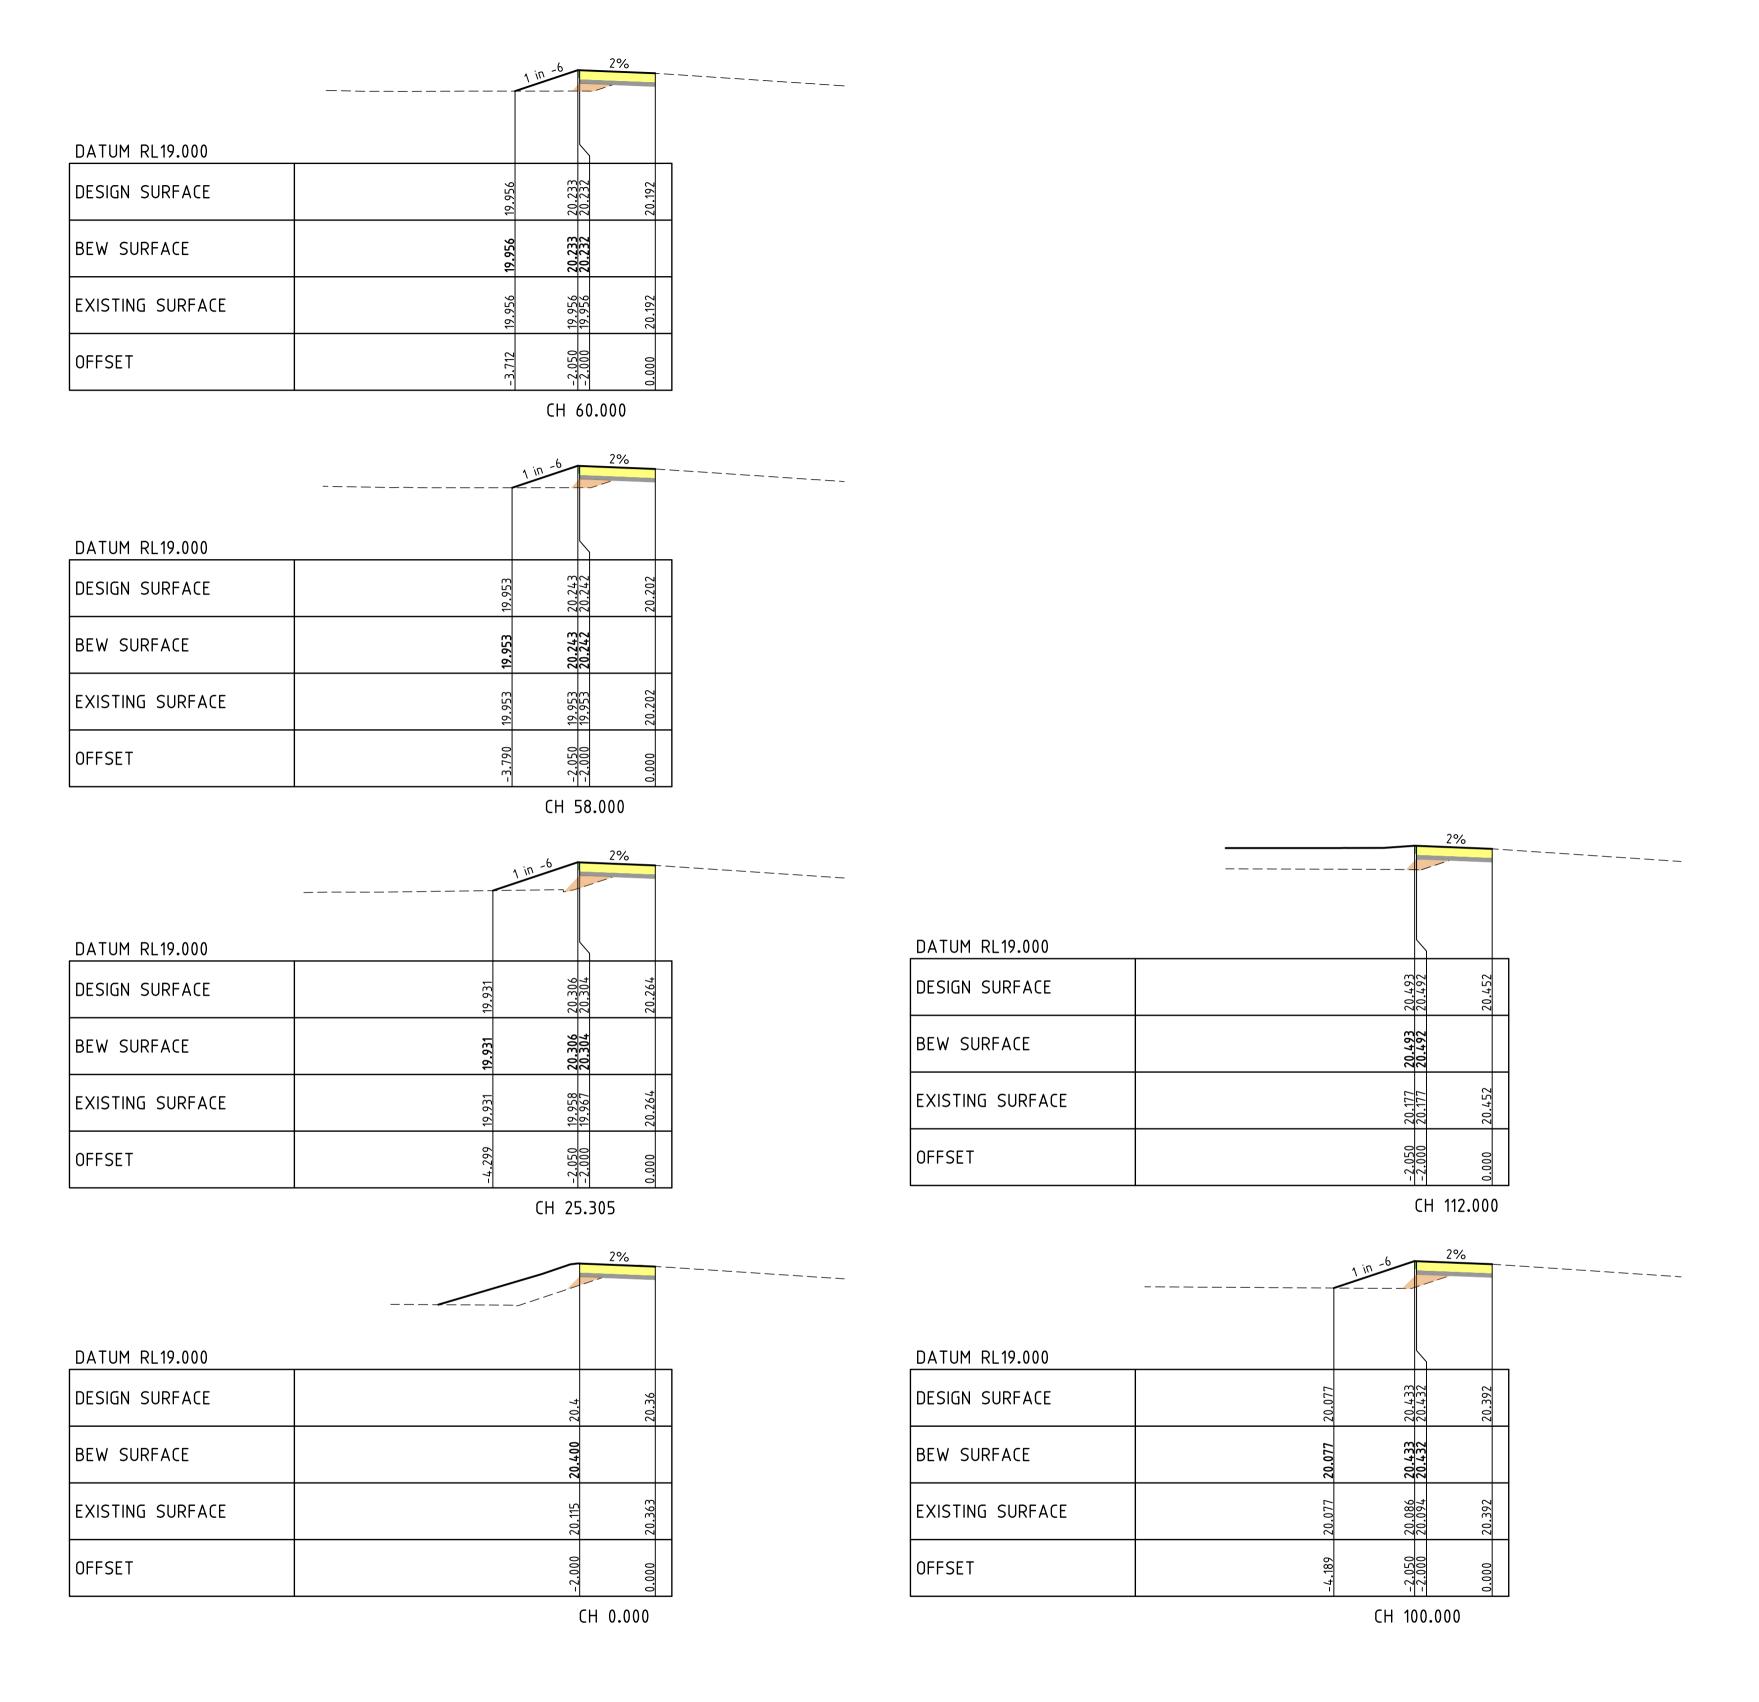
Scale @ A1/A3 H1:500/1000 V1:50/100

RIVERWALK STAGE 40 GEELONG ROAD, WERRIBEE WYNDHAM CITY COUNCIL **FOOTPATH DETAIL SHEET 01 OF 02** Drawing No. 10940FD01

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Rev D

DALTON CONSULTING wurundjeri **T** +61 3 9813 7400 **geelong** wadawurrung **T** +61 3 5246 1700 turrbal **T** +61 7 3374 9000 E info@dceng.com.au



CROSS SECTIONS FARM ROAD FOOTPATH E

LEGEND

---- EXISTING SURFACE

STRUCTURAL FILL

R.GUTIERREZ 14/09/22 NOT TO BE USED FOR CONSTRUCTION 3401095 Designed P.NICHOLSON 13/09/22 3791018 D COUNCIL COMMENTS 29/11/22 30/11/22 PN/SR TL Checked S.RAJKOVIC Date 21/09/22 C COUNCIL COMMENTS 24/10/22 17/11/22 GA 21/09/22 PN/RG B | COUNCIL ISSUE 14/09/22 PN/NR TL Date A TENDER ISSUE REV DESCRIPTION Written dimensions to take precedence over scale. Contractor shall check and verify all dimensions on site. Discrepancies to be brought to the attention of the Superintendent.





RIVERWALK STAGE 40 GEELONG ROAD, WERRIBEE WYNDHAM CITY COUNCIL **FOOTPATH DETAIL SHEET 02 OF 02** Drawing No. 10940FD02 Scale @ A1/A3 H1:500/1000 V1:50/100

Rev D



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NOTE: TYPE A STRUCTURAL FILL

NOTE: BULK EARTHWORKS (BEW)

FILL TO BE COMPLETED AS PART OF PERMIT 11 BULK EARTHWORKS PACKAGE WHICH IS TO BE COMPLETED PRIOR TO SUBDIVISIONAL CIVIL WORKS (REFER TO DCE PROJECT

NOTE: ALL OTHER FILL

WITH APPROVED FILL MATERIAL

REFERENCE NUMBER 10870)


TYPE A STRUCTURAL FILL MATERIAL IN ACCORDANCE WITH THE REQUIREMENTS OF TABLE 201.10Q OF THE WYNDHAM CITY COUNCIL SUBDIVISION GUIDELINES AND SHALL BE FREE OF TOPSOIL, DELETERIOUS MATERIAL AND PERISHABLE MATTER. ALL FILL AREAS MUST ENSURE LEVEL 1 SUPERVISION IS MAINTAINED PER AS3798-2007

FILLING COMPACTED TO AS3798-2007 LEVEL 1 REQUIREMENTS

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 brisbane
 turrbal
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13/09/22 Date **GEELONG ROAD, WERRIBEE DEVELOPMEN** FILLING OVER 200mm 3791018 wurundjeri **T** +61 3 9813 7400 WYNDHAM CITY COUNCIL D COUNCIL COMMENTS 29/11/22 geelong wadawurrung T+61352461700 30/11/22 PN/SR TL TURN AREA OPEN EARTH DRAIN FINISHED SURFACE LEVEL S.RAJKOVIC Checked turrbal **T** +61 7 3374 9000 brisbane 21/09/22 LANEWAY CONCRETE PAVEMENT Date C COUNCIL COMMENTS 24/10/22 17/11/22 GA ES20.06 EX. SURFACE LEVEL -----RW------ RECYCLED WATER EX. TREE TO REMAIN ASPHALT PAVEMENT Coords: MGA Levels: AHD dceng.com.au 2951057 === DW/NDW/GAS CONDUITS B | COUNCIL ISSUE EX. TREE TO BE REMOVED 21/09/22 PN/RG TOB21.650 CONCRETE PATH | D'WAY **DETAILS** Approve A TENDER ISSUE 14/09/22 PN/NR EX. DRAIN & PIT PREVIOUSLY REMOVED TR CONCRETE PARKING BAY SIGNAGE Drawing No. LD01 Rev D REV DESCRIPTION —Ex S—O— EX. SEWER MAIN & MH SERVICE TO BE ABANDONED LANDSCAPING (BY OTHERS) www.byda.com.au Sheet No. 19 of 40 Scale @ A1/A3 1:200 / 1:400

MINOR FS CONTOUR

FINISHED SURFACE

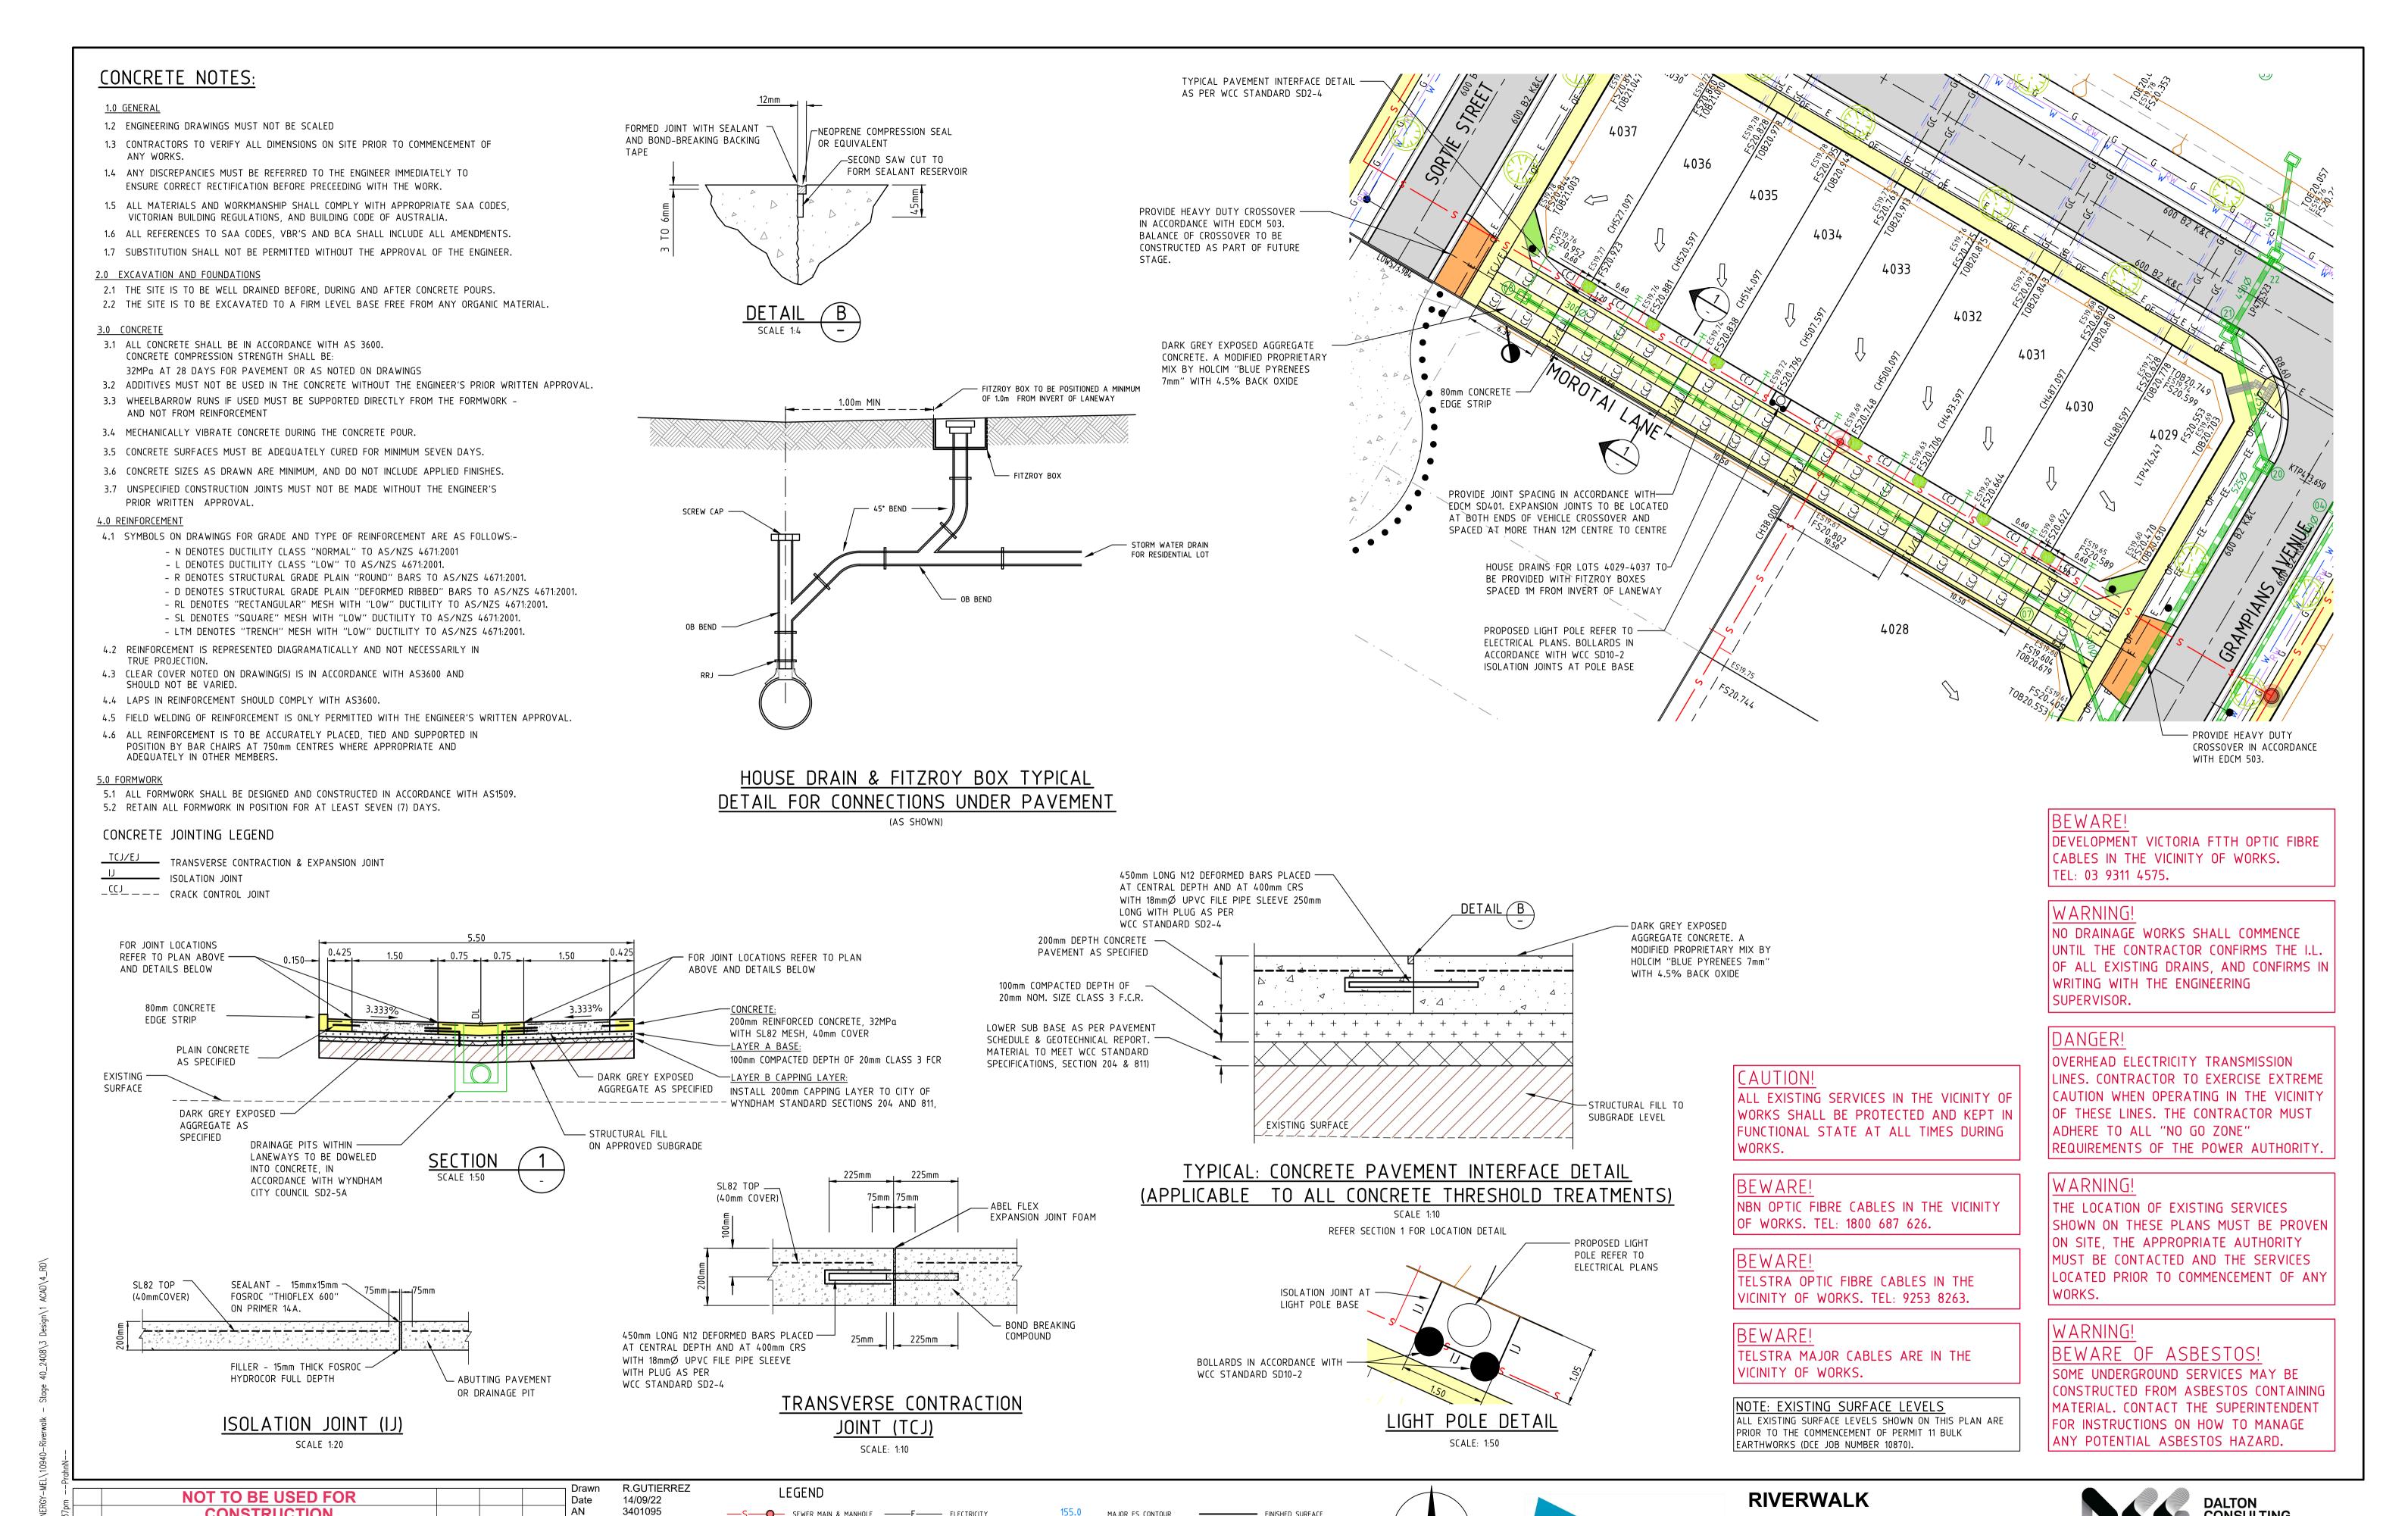— — — — EXISTING SURFACE

155.0 MAJOR FS CONTOUR

Designed P.NICHOLSON

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CONSTRUCTION

Written dimensions to take precedence over scale. Contractor shall check and verify all dimensions on site. Discrepancies to be brought to the attention of the Superintendent.

STAGE 40

CONSULTING

ENGINEERS

E info@dceng.com.au


NOTE: ALL OTHER FILL FILLING COMPACTED TO AS3798-2007 LEVEL 1 REQUIREMENTS WITH APPROVED FILL MATERIAL


NOTE: TYPE A STRUCTURAL FILL

TYPE A STRUCTURAL FILL MATERIAL IN ACCORDANCE WITH THE REQUIREMENTS OF TABLE 201.10Q OF THE WYNDHAM CITY COUNCIL SUBDIVISION GUIDELINES AND SHALL BE FREE OF TOPSOIL, DELETERIOUS MATERIAL AND PERISHABLE MATTER. ALL FILL AREAS MUST ENSURE LEVEL 1 SUPERVISION IS MAINTAINED PER AS3798-2007


NOTE: BULK EARTHWORKS (BEW)

FILL TO BE COMPLETED AS PART OF PERMIT 11 BULK EARTHWORKS PACKAGE WHICH IS TO BE COMPLETED PRIOR TO SUBDIVISIONAL CIVIL WORKS (REFER TO DCE PROJECT REFERENCE NUMBER 10870)

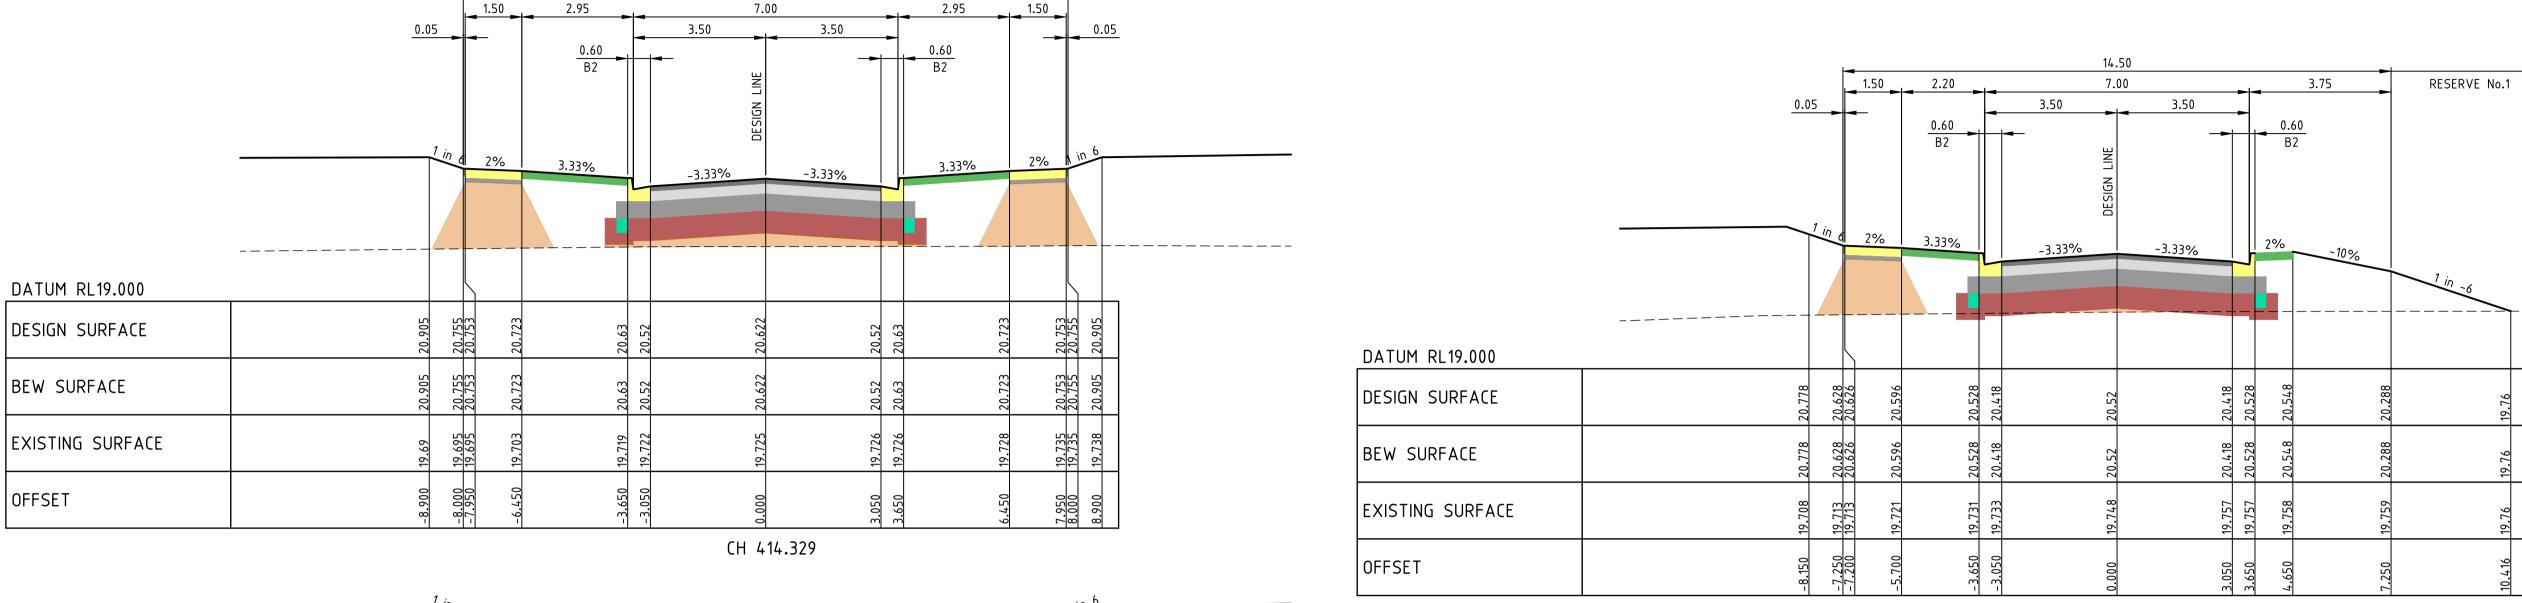

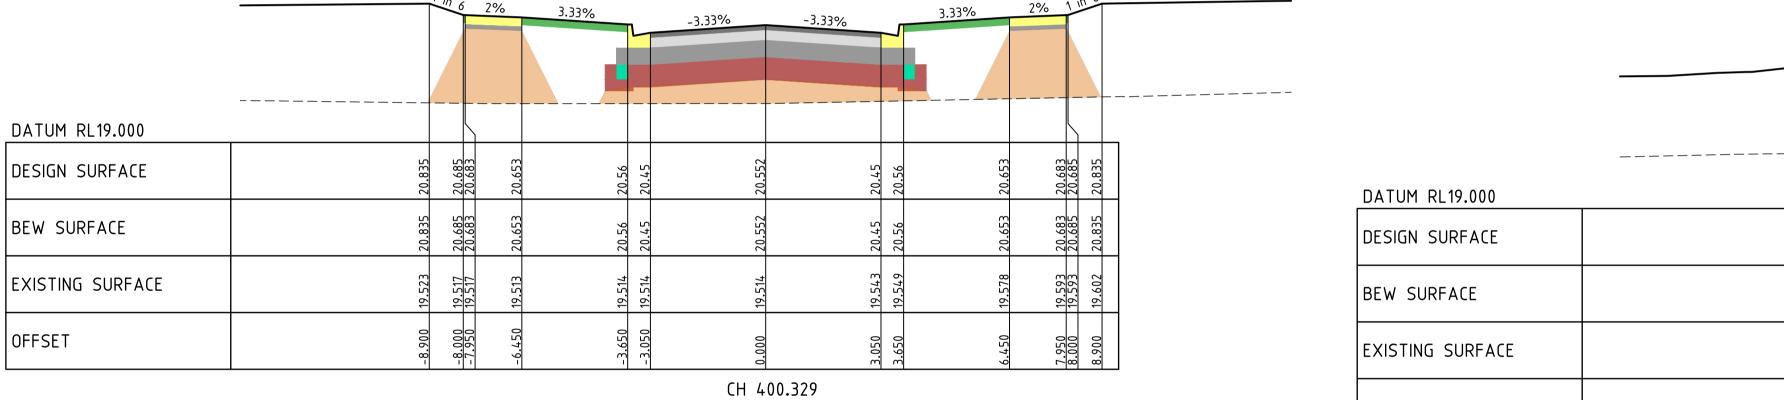

16.00

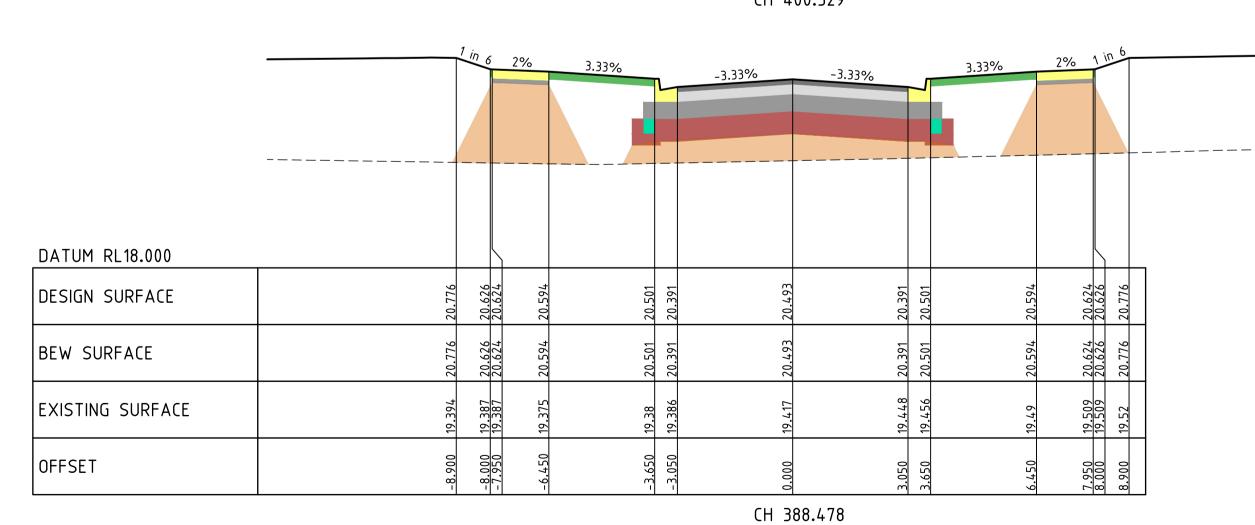

_____ OFFSET CH 476.247

CH 480.597

| | | 1 in 6 | 2% | 3.33% | | -3.33% -3.33% | | 5 | 3.33% | 2% | 7 11 | n 6 |
|------------------|--------|--------|----------|--------|--------|---------------|--------|--------|--------|---|--------|--------|
| DATUM RL19.000 | | | | | | | | | | | | |
| DESIGN SURFACE | 20.908 | 20.758 | 20.756 | | 20.523 | 20.624 | 20.523 | 20.633 | 20.726 | 711.00 | 20.758 | 20.908 |
| BEW SURFACE | 20.908 | 20.758 | 20.756 | (| 20.523 | 20.624 | 20.523 | 20.633 | 20.726 | 711.00 | 20.758 | 20.908 |
| EXISTING SURFACE | 19.691 | 19.696 | 19.696 | , ; | 19.723 | 19.733 | 19.734 | 19.734 | 19.735 | ,,,,,,,,,,,,,,,,,,,,,,,,,,,,,,,,,,,,,,, | 19.742 | 19.744 |
| OFFSET | -8.900 | | | ć L | -3.050 | 0.000 | 3.050 | 3.650 | 6.450 | | 8.000 | 8.900 |
| | | • | <u>'</u> | | | CH 414.843 | • | | | | | • |

KAILASH ROAD

| 2 | | | | | | | | | | | |
|-----------|------------|---|--------------------|------------------|-------|---------------|---------------------------|---|----------------------------|------------------------|--|
| 7 n | | NOT TO BE USED FOR | | | | Drawn Date | R.GUTIERREZ 14/09/22 | L | EGEND | | |
| :38pr | | CONSTRUCTION | | | | AN | 3401095 | | ASPHALT | - EXISTING SURFACE | |
| - | | | | | | Designed | P.NICHOLSON | | BASE | FINISHED SURFACE | |
| 707 | | | | | | Date AN | 13/09/22 3791018 | | SUBBASE | BEW SURFACE | |
| 30, | D | COUNCIL COMMENTS 29/11/22 | 30/11/22 | PN/SR | TL | Checked | S.RAJKOVIC | | CAPPING/CONSTRUCTION LAYER | | |
| 2 | С | COUNCIL COMMENTS 24/10/22 | 17/11/22 | GA | TL | Date AN | 21/09/22 2951057 | | AG DRAIN | | |
| Wed | В | COUNCIL ISSUE | 21/09/22 | PN/RG | TL | Approved | 2931037 | | CONCRETE | | |
| me: | Α | TENDER ISSUE | 14/09/22 | PN/NR | TL | Date | | | TOPSOIL & SEED | | |
| rte/ | REV | DESCRIPTION | DATE | AMEND | APP'D | AN | | | STRUCTURAL FILL | | |
| \preceq | Written di | imensions to take precedence over scale. Contractor shall check and verify all dimensions on site. Discrepancies to be brought to | o the attention of | the Superintende | nt. | © Dalton Cons | sulting Engineers Pty Ltd | | | | |



Scale @ A1/A3 H1:100/200 V1:50/100



RIVERWALK GEELONG ROAD, WERRIBEE WYNDHAM CITY COUNCIL **CROSS SECTIONS SHEET 01 OF 10** Drawing No. 10940XS01 Rev D



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 E info@dceng.com.au dceng.com.au




NOTE: ALL OTHER FILL FILLING COMPACTED TO AS3798-2007 LEVEL 1 REQUIREMENTS WITH APPROVED FILL MATERIAL


NOTE: TYPE A STRUCTURAL FILL


TYPE A STRUCTURAL FILL MATERIAL IN ACCORDANCE WITH THE REQUIREMENTS OF TABLE 201.10Q OF THE WYNDHAM CITY COUNCIL SUBDIVISION GUIDELINES AND SHALL BE FREE OF TOPSOIL, DELETERIOUS MATERIAL AND PERISHABLE MATTER. ALL FILL AREAS MUST ENSURE LEVEL 1 SUPERVISION IS MAINTAINED PER AS3798-2007


NOTE: BULK EARTHWORKS (BEW)


FILL TO BE COMPLETED AS PART OF PERMIT 11 BULK EARTHWORKS PACKAGE WHICH IS TO BE COMPLETED PRIOR TO SUBDIVISIONAL CIVIL WORKS (REFER TO DCE PROJECT REFERENCE NUMBER 10870)

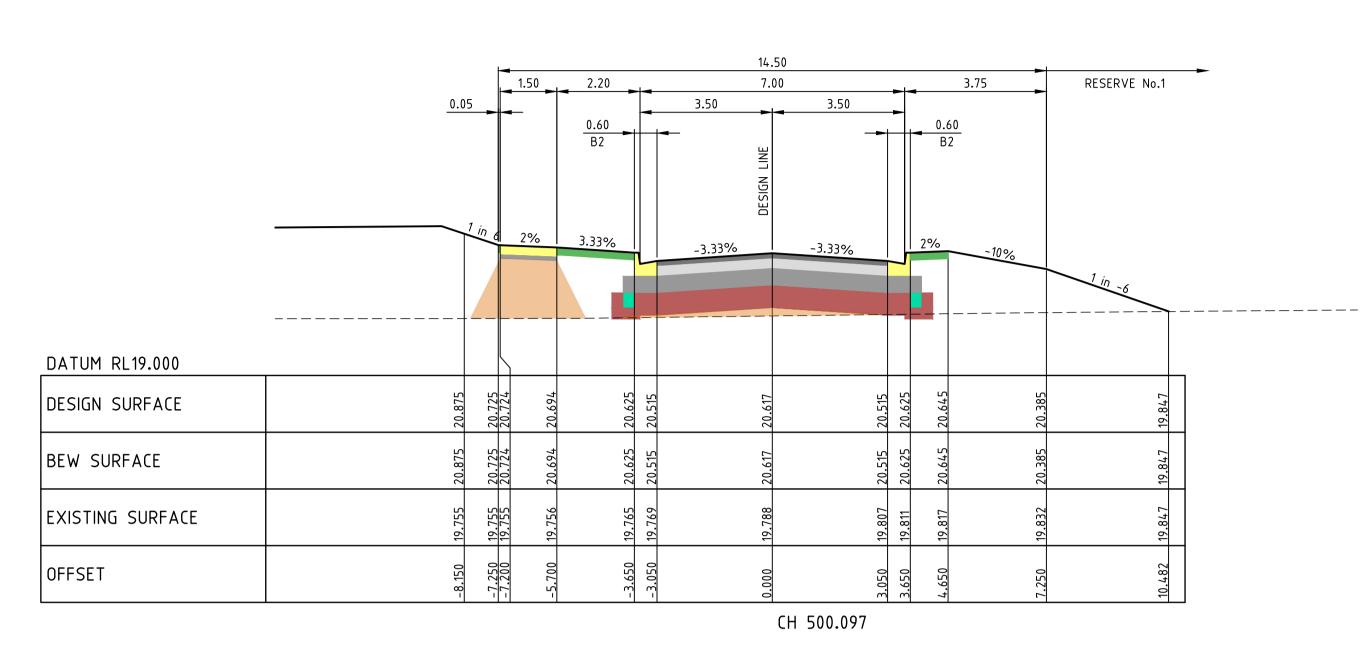

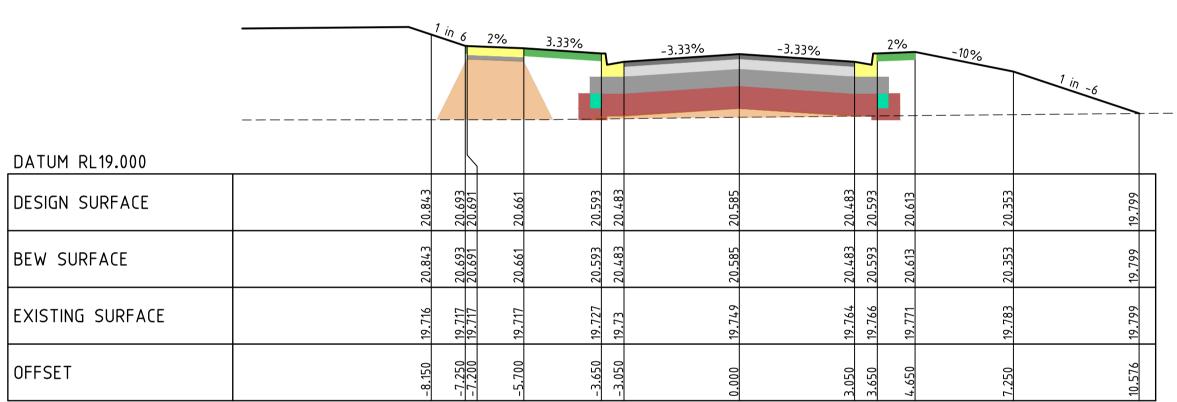

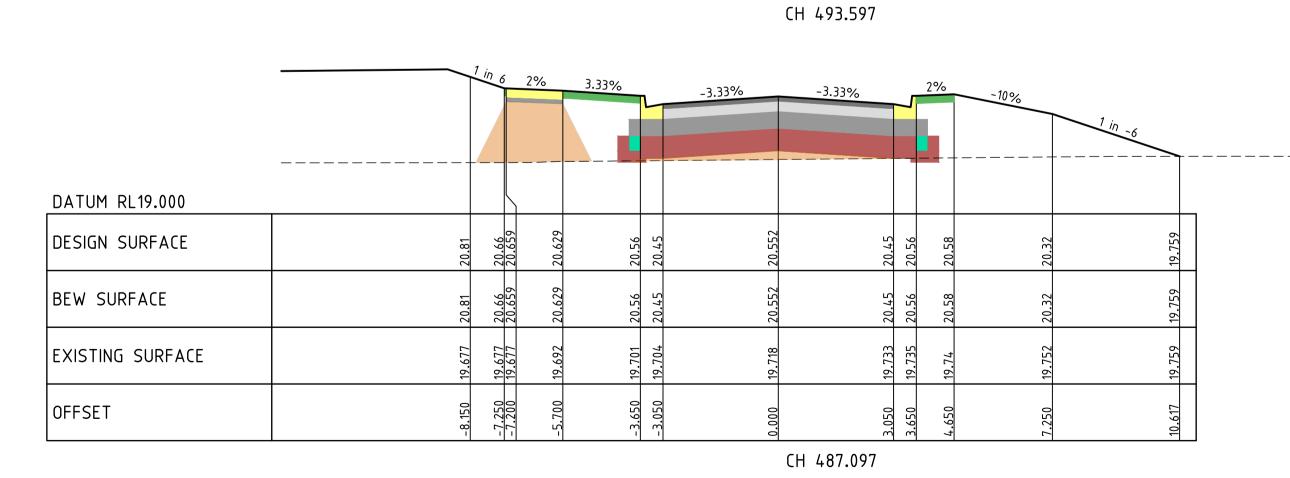

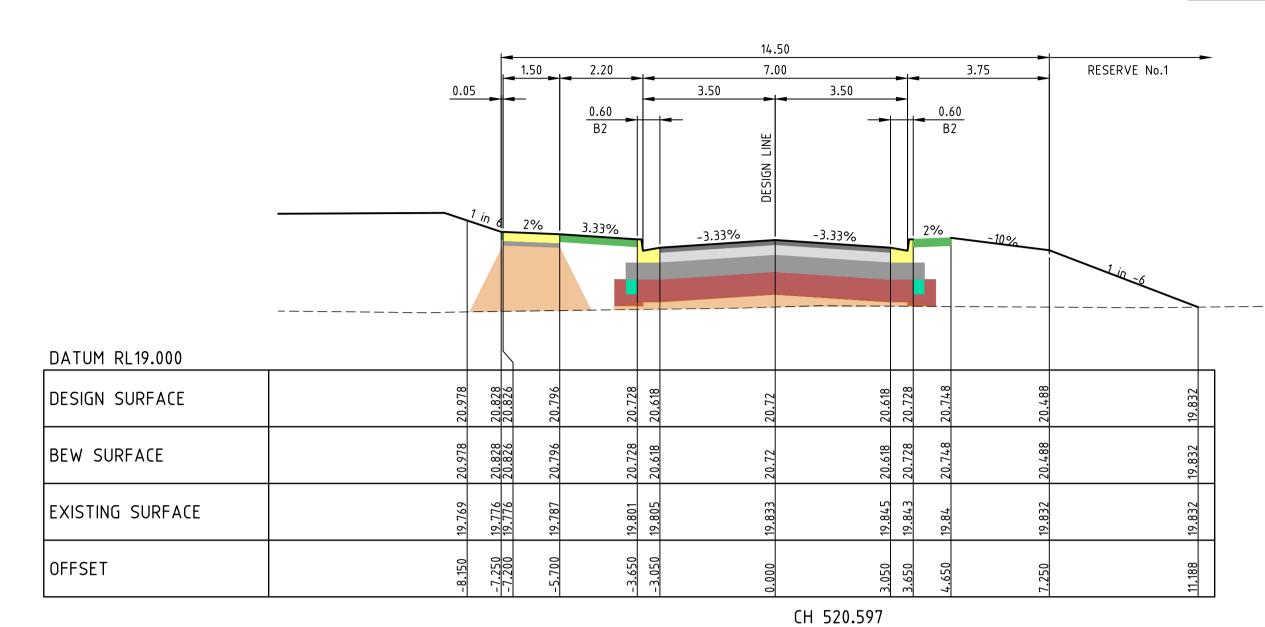

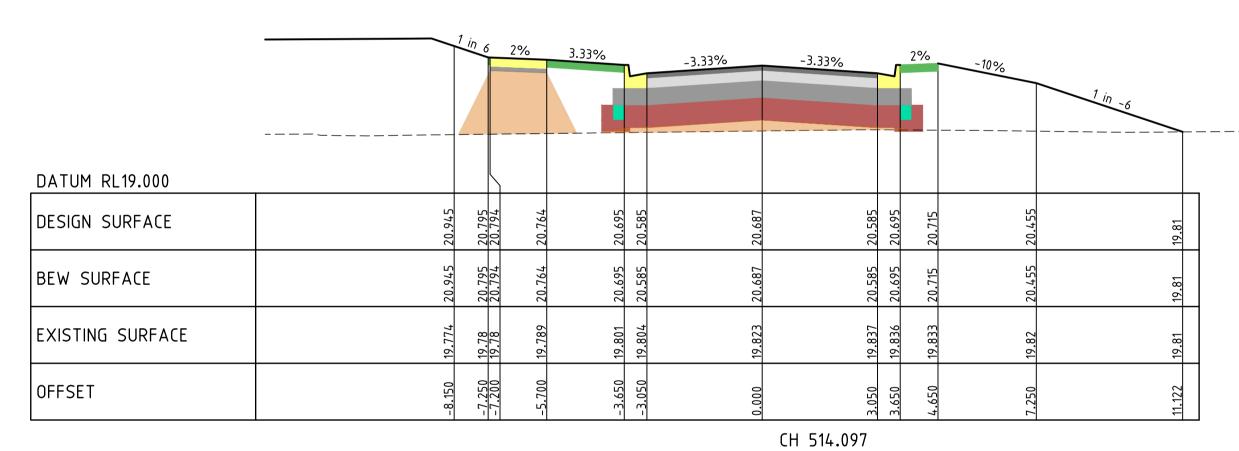

| | 1 in 6 29 | % 3.33% | -3.33% | -3.33% 2% | 10% | 1 in -6 | |
|------------------|----------------------------|----------------------------|--------|----------------------------|--------|---------|--|
| DATUM RL19.000 | | | | | | | |
| DESIGN SURFACE | 20.913 20.763 20.761 | 20.731 | 20.655 | 20.553 20.663 20.683 | 20.423 | 19.818 | |
| BEW SURFACE | 20.913 20.763 20.763 | 20.731 20.663 20.553 | 20.655 | 20.553 20.663 20.683 | 20.423 | 19.818 | |
| EXISTING SURFACE | 19.768 19.769 19.769 | 19.776 | 19.81 | 19.829 19.833 19.839 | 19.852 | 19.818 | |
| OFFSET | -8.150 -7.250 -7.200 | -5.700 -3.650 -3.050 | 0.000 | 3.050 3.650 4.650 | 7.250 | 10.877 | |
| | | | CH | 507.597 | | | |

KAILASH ROAD

| 2 | | | | | | | | | | |
|--------|------------|--|------------------|------------------|-------|------------------|---------------------------|---|-------------------------------|----------------------|
| | | NOT TO BE USED FOR | | | | Drawn Date | R.GUTIERREZ 14/09/22 | L | .EGEND | |
| idoc. | | CONSTRUCTION | | | | AN | 3401095 | | ASPHALT | EXISTING SURFACE |
| 1 | | | | | | Designed Date | P.NICHOLSON 13/09/22 | | BASE | FINISHED SURFACE |
| 7707 | | | | | | AN | 3791018 | | SUBBASE | BEW SURFACE |
| ς, | D | COUNCIL COMMENTS 29/11/22 | 30/11/22 | PN/SR | TL | Checked | S.RAJKOVIC | | CAPPING/CONSTRUCTION LAYER | |
| 2 | С | COUNCIL COMMENTS 24/10/22 | 17/11/22 | GA | TL | Date AN | 21/09/22 2951057 | | AG DRAIN | |
| ne. | В | COUNCIL ISSUE | 21/09/22 | PN/RG | TL | | | | CONCRETE | |
| : E | Α | TENDER ISSUE | 14/09/22 | PN/NR | TL | Approved Date | | | TOPSOIL & SEED | |
| re/ I | REV | DESCRIPTION | DATE | AMEND | APP'D | AN | = = | | STRUCTURAL FILL | |
| ĭ | Written di | mensions to take precedence over scale. Contractor shall check and verify all dimensions on site. Discrepancies to be brought to | the attention of | the Superintende | ent. | © Dalton Cons | sulting Engineers Pty Ltd | | | |








RIVERWALK STAGE 40 **GEELONG ROAD, WERRIBEE** WYNDHAM CITY COUNCIL **CROSS SECTIONS SHEET 02 OF 10** Drawing No. 10940XS02 Rev D




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SORTIE STREET

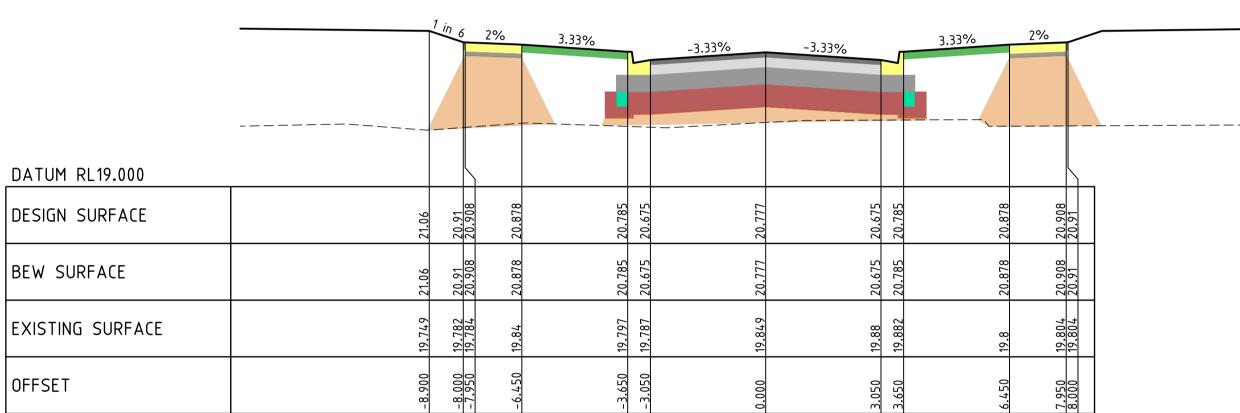

Date

Date

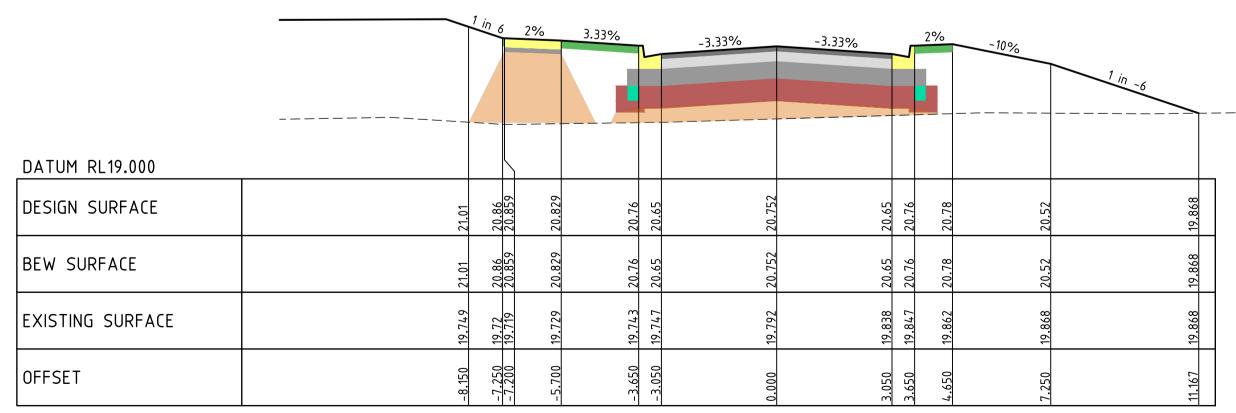30/11/22 PN/SR TL

21/09/22 PN/RG TL

14/09/22 PN/NR TL Date

17/11/22 GA

NOT TO BE USED FOR

CONSTRUCTION

Written dimensions to take precedence over scale. Contractor shall check and verify all dimensions on site. Discrepancies to be brought to the attention of the Superintendent.

D COUNCIL COMMENTS 29/11/22

C COUNCIL COMMENTS 24/10/22

B COUNCIL ISSUE

REV DESCRIPTION

트등 할 A TENDER ISSUE

KAILASH ROAD

R.GUTIERREZ 14/09/22

3401095

13/09/22

3791018

21/09/22

2951057

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Designed P.NICHOLSON

Checked S.RAJKOVIC

Coords: MGA Levels: AHD



EXISTING STOCKPILE TO BE — REMOVED AS PART OF BEW PACKAGE. (REFER TO DCE JOB

1.50

2.95

3.33%

NUMBER 1870)

DATUM RL18.000

DESIGN SURFACE

BEW SURFACE

OFFSET

EXISTING STOCKPILE TO BE —— REMOVED AS PART OF BEW PACKAGE. (REFER TO DCE JOB

DATUM RL18.000

DESIGN SURFACE


BEW SURFACE

OFFSET

EXISTING SURFACE

NUMBER 1870)

EXISTING SURFACE

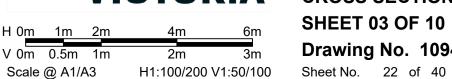

STAGE 40 GEELONG ROAD, WERRIBEE WYNDHAM CITY COUNCIL **CROSS SECTIONS SHEET 03 OF 10 Drawing No. 10940XS03** Rev D



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22.605 22.603 22.577

NOTE: TYPE A STRUCTURAL FILL

NOTE: BULK EARTHWORKS (BEW)

REFERENCE NUMBER 10870)

NOTE: ALL OTHER FILL

WITH APPROVED FILL MATERIAL

1.50

19.845 19.847 19.997

,~-----

2.95

0.60

16.00

7.00

CH 335.475

CH 332.855 L.O.W.

GRAMPIANS AVENUE

3.50

-3.33%

3.50

FILL TO BE COMPLETED AS PART OF PERMIT 11 BULK

EARTHWORKS PACKAGE WHICH IS TO BE COMPLETED PRIOR TO SUBDIVISIONAL CIVIL WORKS (REFER TO DCE PROJECT

FILLING COMPACTED TO AS3798-2007 LEVEL 1 REQUIREMENTS


TYPE A STRUCTURAL FILL MATERIAL IN ACCORDANCE WITH THE REQUIREMENTS OF TABLE 201.10Q OF THE WYNDHAM CITY COUNCIL SUBDIVISION GUIDELINES AND SHALL BE FREE OF TOPSOIL, DELETERIOUS MATERIAL AND PERISHABLE MATTER. ALL FILL AREAS MUST ENSURE LEVEL 1 SUPERVISION IS MAINTAINED PER AS3798-2007

PRELIMINARY


8.000 -7.950

RIVERWALK



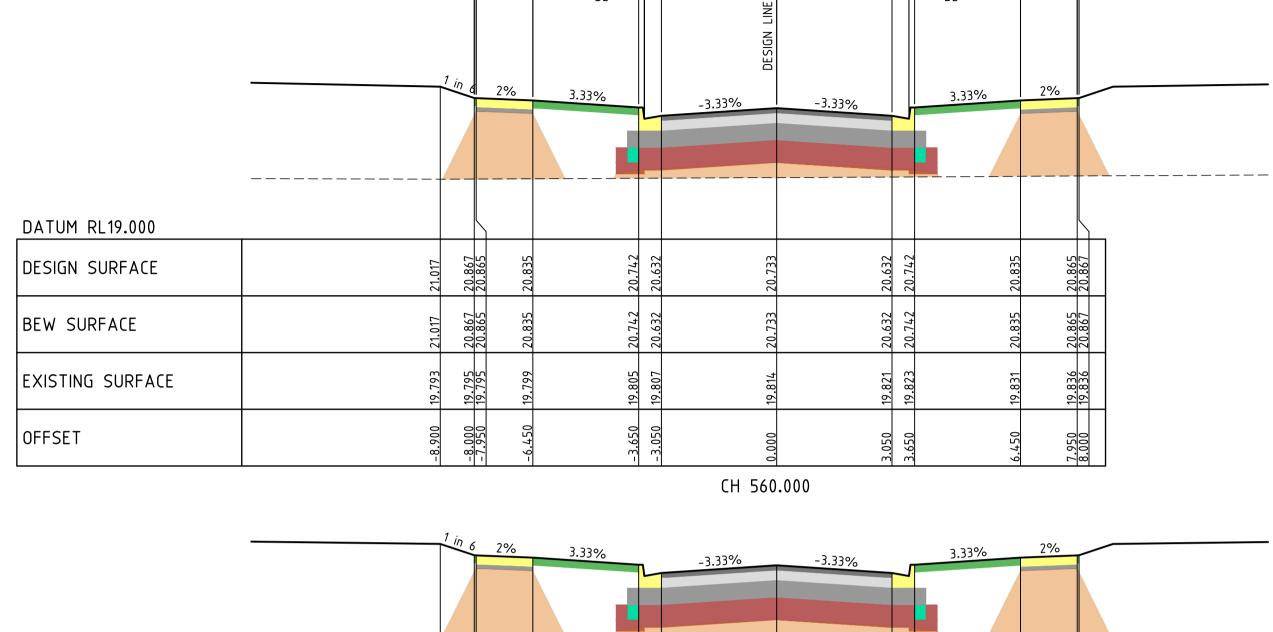

CH 552.384

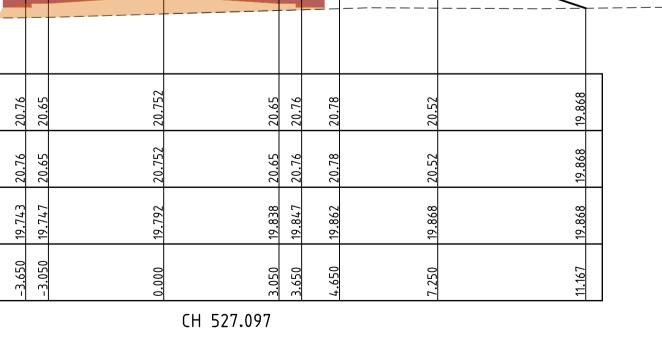

LEGEND

SUBBASE

AG DRAIN

CONCRETE

TOPSOIL & SEED


STRUCTURAL FILL

CAPPING/CONSTRUCTION LAYER

---- EXISTING SURFACE

FINISHED SURFACE

----- BEW SURFACE

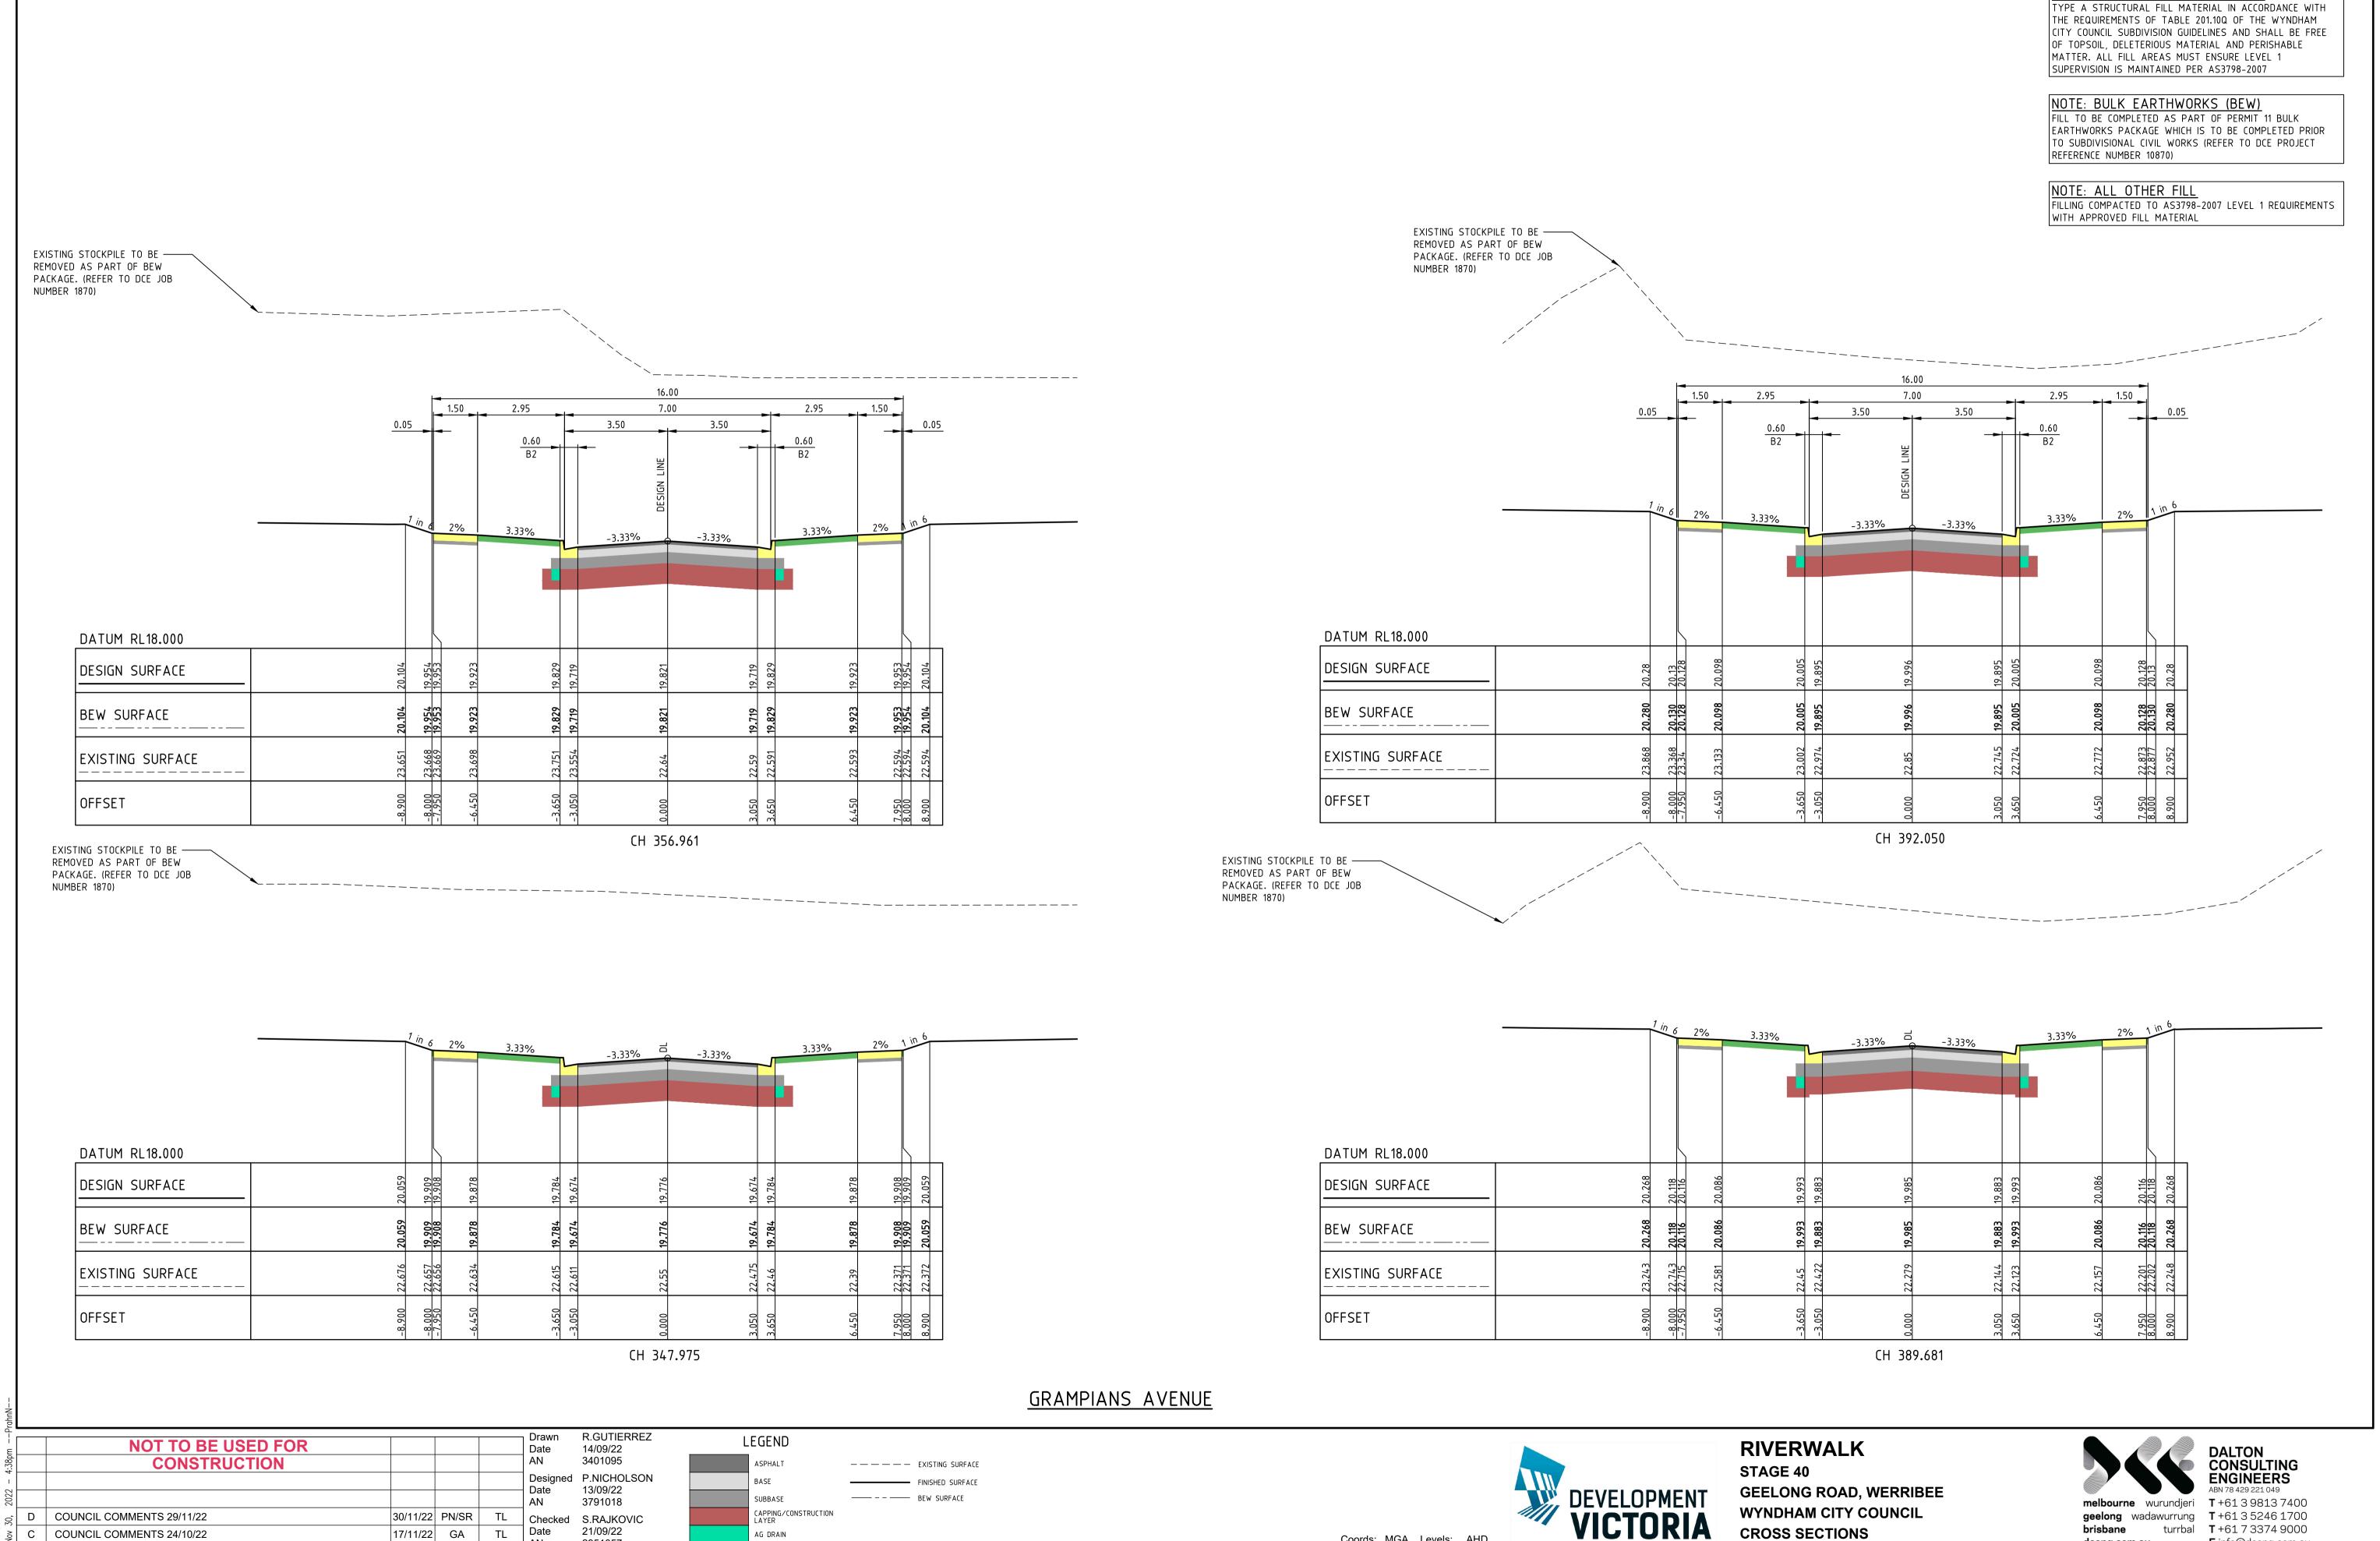

Coords: MGA Levels: AHD

Scale @ A1/A3

H1:100/200 V1:50/100

NOTE: TYPE A STRUCTURAL FILL

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SHEET 04 OF 10

Sheet No. 23 of 40

Drawing No. 10940XS04

Rev D

C COUNCIL COMMENTS 24/10/22

Written dimensions to take precedence over scale. Contractor shall check and verify all dimensions on site. Discrepancies to be brought to the attention of the Superintendent.

B COUNCIL ISSUE

je A TENDER ISSUE

REV DESCRIPTION

Date

17/11/22 GA

21/09/22 PN/RG TL

14/09/22 PN/NR TL Date

DATE AMEND APP'D AN

21/09/22

2951057


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AG DRAIN

CONCRETE

TOPSOIL & SEED

STRUCTURAL FILL

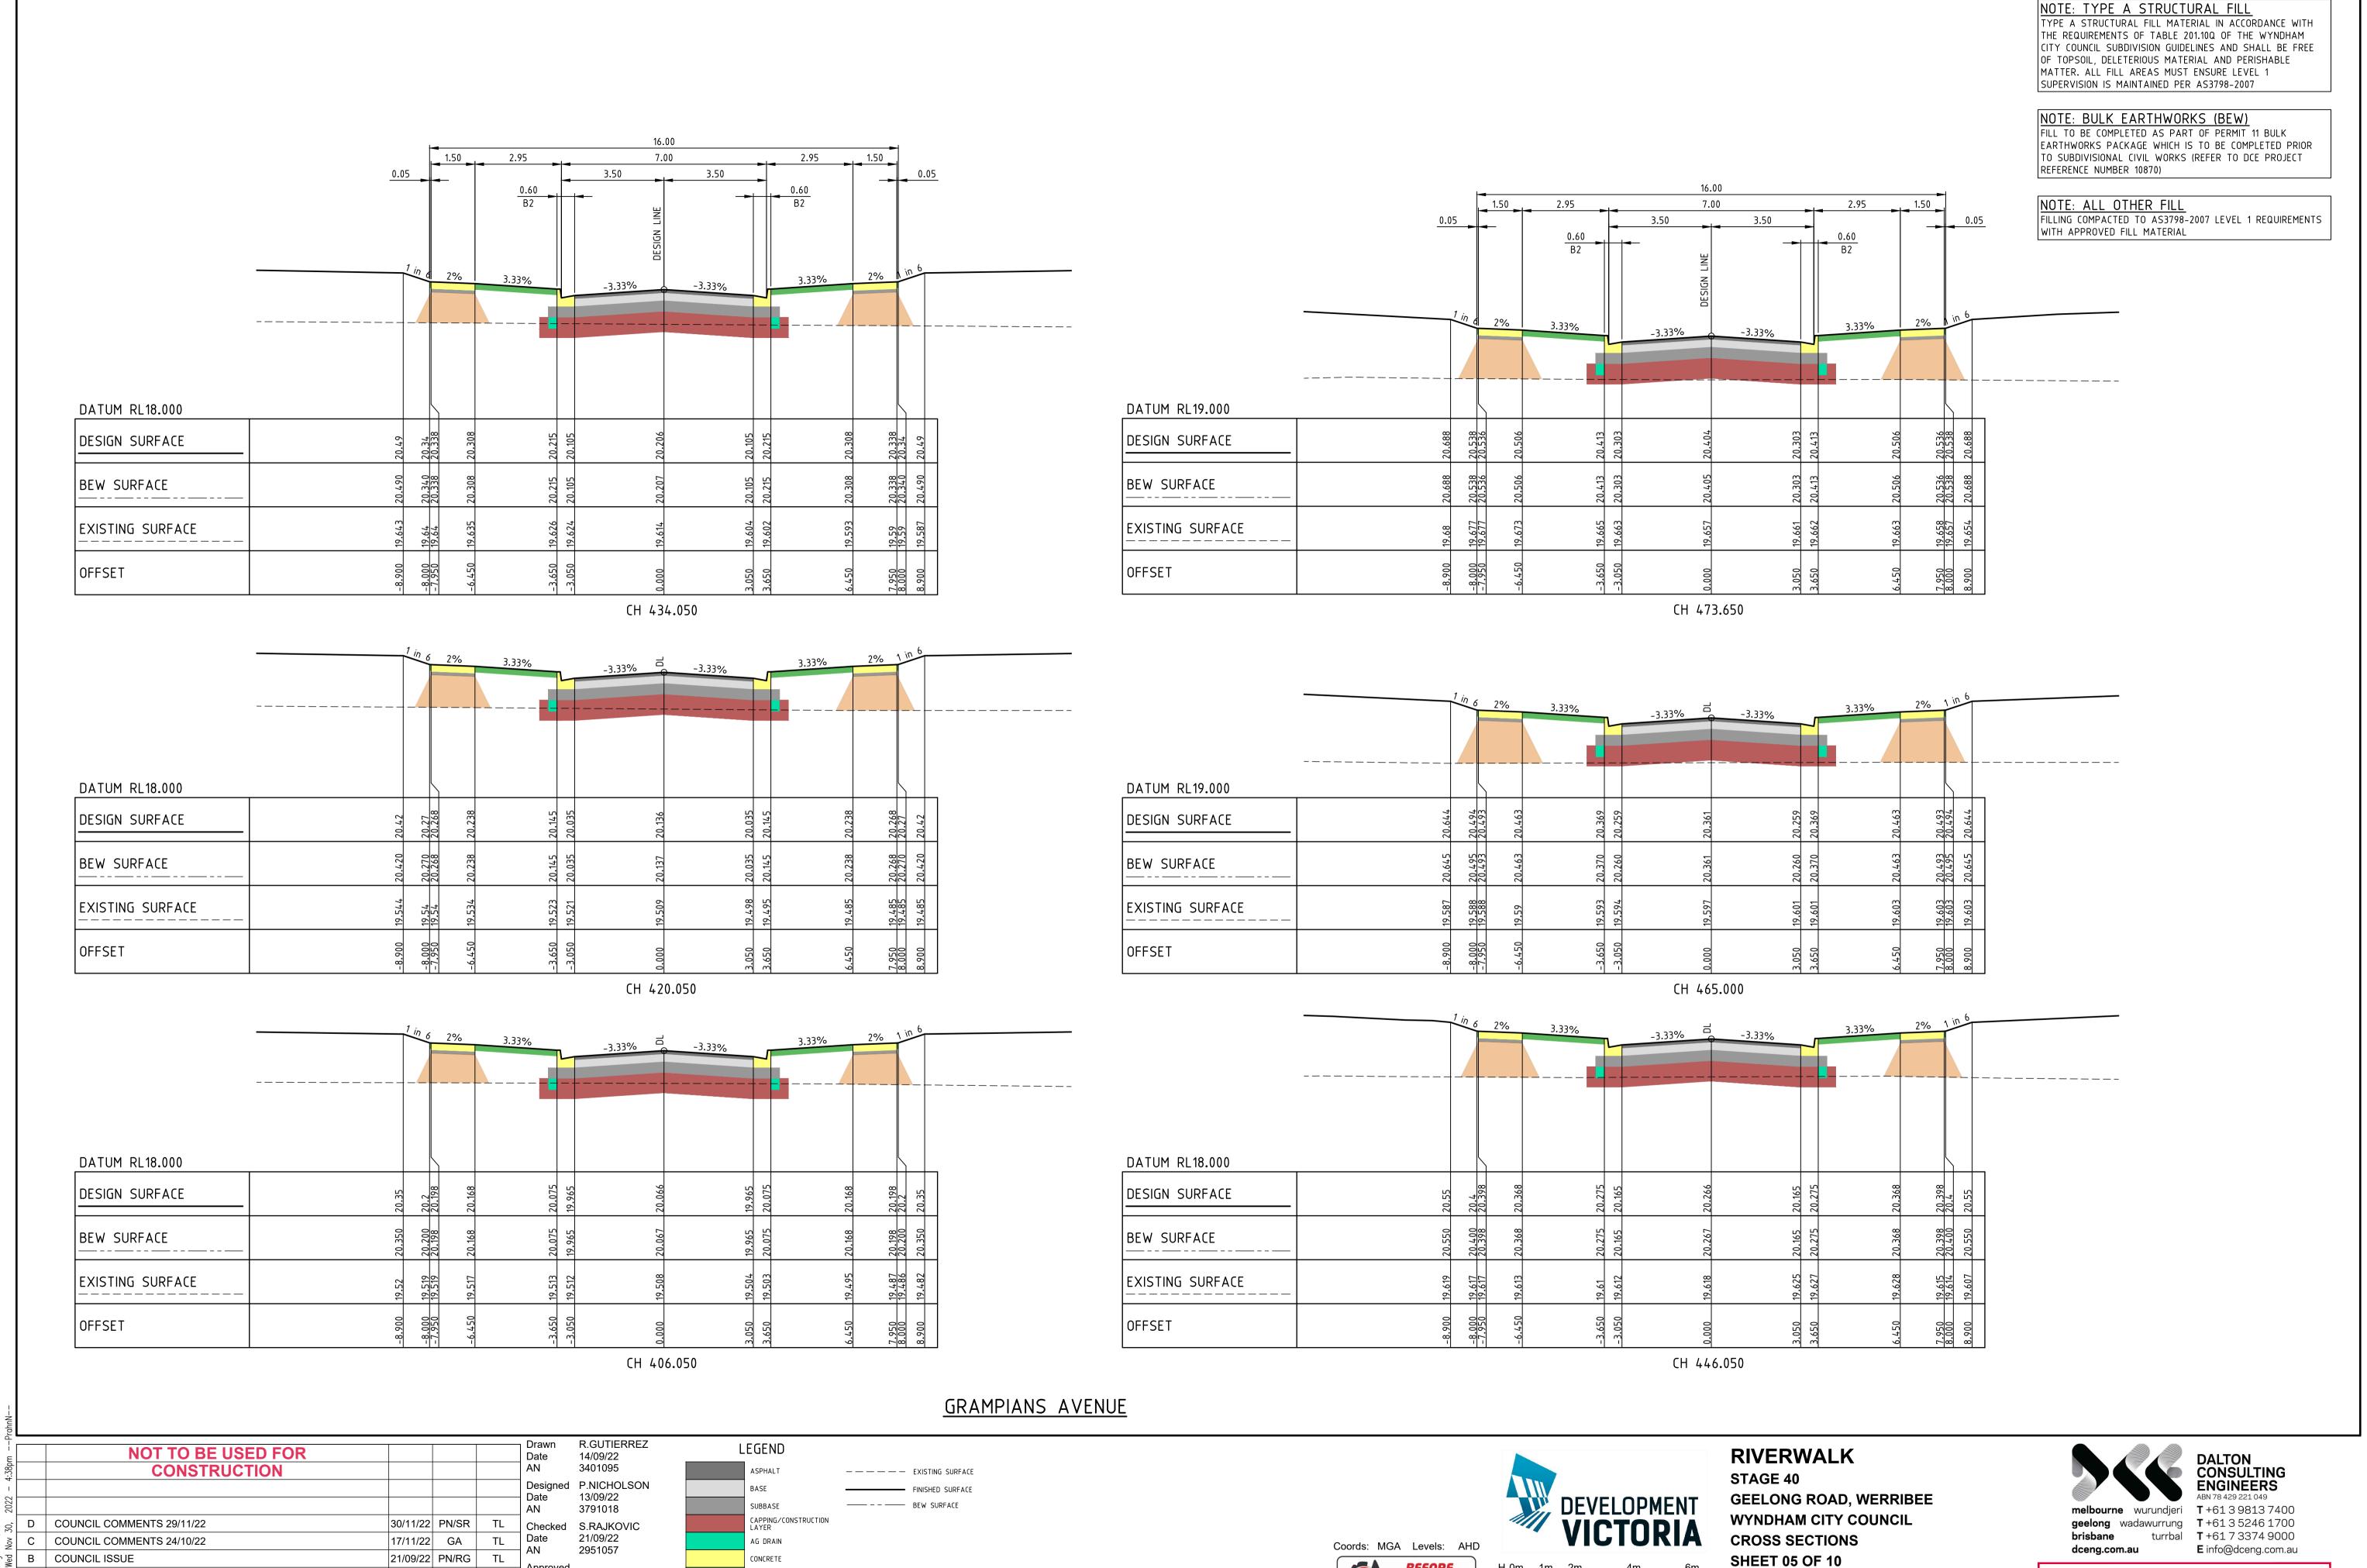

PRELIMINARY

Drawing No. 10940XS05

Sheet No. 24 of 40

Scale @ A1/A3

H1:100/200 V1:50/100

Rev D

REV DESCRIPTION

Written dimensions to take precedence over scale. Contractor shall check and verify all dimensions on site. Discrepancies to be brought to the attention of the Superintendent.

14/09/22 PN/NR TL Date

DATE AMEND APP'D AN

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TOPSOIL & SEED

STRUCTURAL FILL

NOTE: BULK EARTHWORKS (BEW) FILL TO BE COMPLETED AS PART OF PERMIT 11 BULK EARTHWORKS PACKAGE WHICH IS TO BE COMPLETED PRIOR TO SUBDIVISIONAL CIVIL WORKS (REFER TO DCE PROJECT REFERENCE NUMBER 10870) NOTE: ALL OTHER FILL FILLING COMPACTED TO AS3798-2007 LEVEL 1 REQUIREMENTS 14.50 WITH APPROVED FILL MATERIAL 14.50 RESERVE No.1 7.00 2.95 2.95 RESERVE No.1 7.00 2.95 _ 1.50 _ 2.95 0.05 3.50 3.50 3.50 3.50 0.60 3.33% -3.33% -3.33% 3.33% -3.33% -----DATUM RL19.000 DATUM RL19.000 DESIGN SURFACE DESIGN SURFACE BEW SURFACE BEW SURFACE 19.824 19.824 19.823 EXISTING SURFACE EXISTING SURFACE OFFSET 7.950 8.000 8.900 OFFSET CH 21.774 CH 42.774 ______ DATUM RL19.000 DATUM RL19.000 20.777 20.777 20.778 20.778 20.928 20.928 DESIGN SURFACE DESIGN SURFACE 20.7 BEW SURFACE BEW SURFACE 19.814 19.814 19.813 EXISTING SURFACE EXISTING SURFACE 7.950 8.000 8.900 OFFSET OFFSET CH 32.274 CH 18.669 DATUM RL19.000 DATUM RL19.000 20.768 20.769 20.919 DESIGN SURFACE DESIGN SURFACE 20.768 20.769 20.919 BEW SURFACE BEW SURFACE 19.785 19.785 19.786 EXISTING SURFACE EXISTING SURFACE 7.950 8.000 8.900 OFFSET OFFSET CH 13.856 CH 24.553 HANGER STREET LEGEND NOT TO BE USED FOR **RIVERWALK** Date AN 14/09/22 3401095 CONSTRUCTION ---- EXISTING SURFACE STAGE 40 Designed P.NICHOLSON FINISHED SURFACE 13/09/22 GEELONG ROAD, WERRIBEE Date ----- BEW SURFACE SUBBASE 3791018 wurundjeri **T** +61 3 9813 7400 WYNDHAM CITY COUNCIL CAPPING/CONSTRUCTION LAYER

Coords: MGA Levels: AHD

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Scale @ A1/A3

D COUNCIL COMMENTS 29/11/22

C COUNCIL COMMENTS 24/10/22

Written dimensions to take precedence over scale. Contractor shall check and verify all dimensions on site. Discrepancies to be brought to the attention of the Superintendent.

B | COUNCIL ISSUE

트등 할 A TENDER ISSUE

REV DESCRIPTION

30/11/22 PN/SR TL

21/09/22 PN/RG TL

14/09/22 PN/NR TL Date

DATE AMEND APP'D AN

17/11/22 GA

Checked S.RAJKOVIC

21/09/22

2951057

© Dalton Consulting Engineers Pty Ltd

AG DRAIN

CONCRETE

TOPSOIL & SEED

STRUCTURAL FILL

Date

TL

NOTE: TYPE A STRUCTURAL FILL

TYPE A STRUCTURAL FILL MATERIAL IN ACCORDANCE WITH THE REQUIREMENTS OF TABLE 201.10Q OF THE WYNDHAM CITY COUNCIL SUBDIVISION GUIDELINES AND SHALL BE FREE OF TOPSOIL, DELETERIOUS MATERIAL AND PERISHABLE MATTER. ALL FILL AREAS MUST ENSURE LEVEL 1 SUPERVISION IS MAINTAINED PER AS3798-2007

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PRELIMINARY

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CROSS SECTIONS

Drawing No. 10940XS06

Rev D

SHEET 06 OF 10


Sheet No. 25 of 40

H1:100/200 V1:50/100

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SUPERVISION IS MAINTAINED PER AS3798-2007 NOTE: BULK EARTHWORKS (BEW) FILL TO BE COMPLETED AS PART OF PERMIT 11 BULK EARTHWORKS PACKAGE WHICH IS TO BE COMPLETED PRIOR TO SUBDIVISIONAL CIVIL WORKS (REFER TO DCE PROJECT REFERENCE NUMBER 10870) NOTE: ALL OTHER FILL FILLING COMPACTED TO AS3798-2007 LEVEL 1 REQUIREMENTS EXISTING STOCKPILE TO BE — WITH APPROVED FILL MATERIAL REMOVED AS PART OF BEW PACKAGE. (REFER TO DCE JOB NUMBER 1870) 16.00 7.00 2.95 2.95 -----0.05 3.50 3.50 0.60 B2 3.33% 3.33% -3.33% DATUM RL18.000 20.039 20.037 DESIGN SURFACE 20.039 20.037 BEW SURFACE 23.506 23.504 EXISTING SURFACE -8.000 OFFSET CH 24.310 - EXISTING STOCKPILE TO BE REMOVED AS PART OF BEW PACKAGE. (REFER TO DCE JOB NUMBER 1870) 7.00 2.95 _______ 3.50 3.50 3.33% 3.33% -3.33% DATUM RL18.000 DESIGN SURFACE 20.008 20.006 BEW SURFACE 23.499 23.497 EXISTING SURFACE -8.000 OFFSET CH 18.717 BATCHELOR STREET **RIVERWALK** DALTON CONSULTING ENGINEERS STAGE 40




HANGER STREET

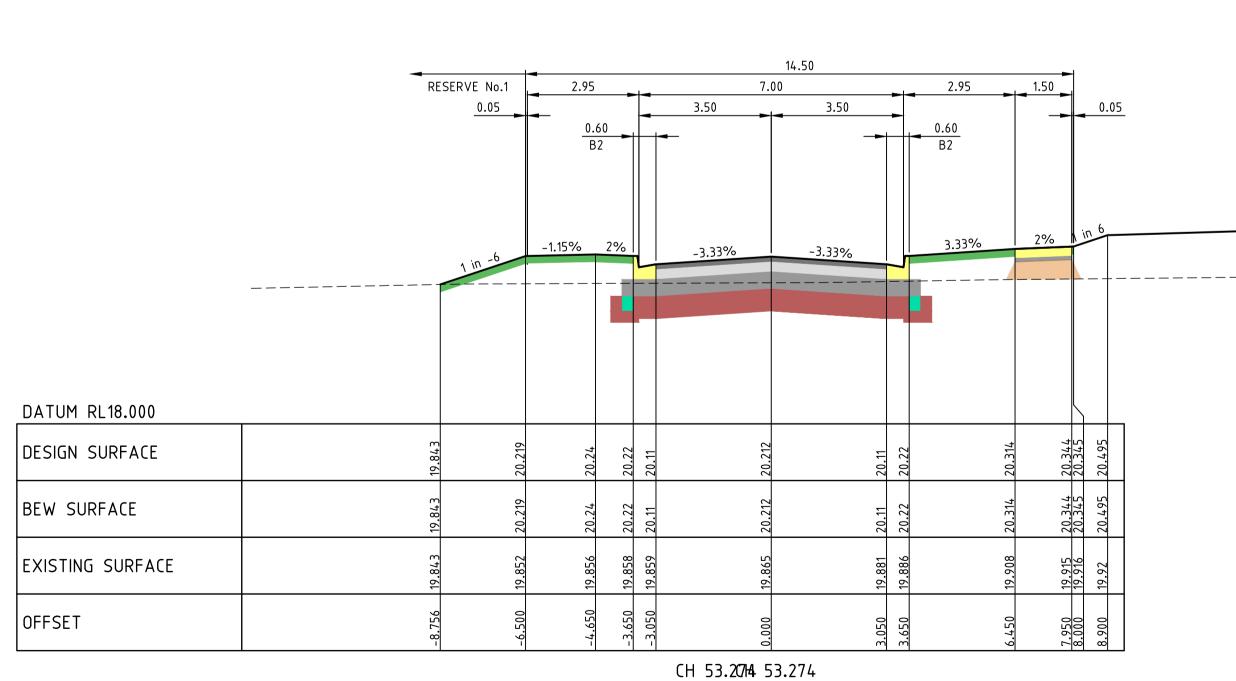R.GUTIERREZ 14/09/22 LEGEND NOT TO BE USED FOR 3401095 CONSTRUCTION ---- EXISTING SURFACE Designed P.NICHOLSON FINISHED SURFACE 13/09/22 ----- BEW SURFACE SUBBASE 3791018 CAPPING/CONSTRUCTION LAYER D COUNCIL COMMENTS 29/11/22 30/11/22 PN/SR TL Checked S.RAJKOVIC Date 21/09/22 17/11/22 GA C COUNCIL COMMENTS 24/10/22 TL AG DRAIN 2951057 B COUNCIL ISSUE 21/09/22 PN/RG TL CONCRETE 14/09/22 PN/NR TL Date हिंहू हूं A | TENDER ISSUE TOPSOIL & SEED REV DESCRIPTION STRUCTURAL FILL © Dalton Consulting Engineers Pty Ltd Written dimensions to take precedence over scale. Contractor shall check and verify all dimensions on site. Discrepancies to be brought to the attention of the Superintendent.





H1:100/200 V1:50/100

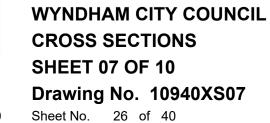

GEELONG ROAD, WERRIBEE

Rev D

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NOTE: TYPE A STRUCTURAL FILL

TYPE A STRUCTURAL FILL MATERIAL IN ACCORDANCE WITH THE REQUIREMENTS OF TABLE 201.10Q OF THE WYNDHAM CITY COUNCIL SUBDIVISION GUIDELINES AND SHALL BE FREE OF TOPSOIL, DELETERIOUS MATERIAL AND PERISHABLE MATTER. ALL FILL AREAS MUST ENSURE LEVEL 1

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FILL TO BE COMPLETED AS PART OF PERMIT 11 BULK EARTHWORKS PACKAGE WHICH IS TO BE COMPLETED PRIOR TO SUBDIVISIONAL CIVIL WORKS (REFER TO DCE PROJECT REFERENCE NUMBER 10870) NOTE: ALL OTHER FILL FILLING COMPACTED TO AS3798-2007 LEVEL 1 REQUIREMENTS WITH APPROVED FILL MATERIAL 16.00 2.95 7.00 2.95 1.50 - EXISTING STOCKPILE TO BE REMOVED AS PART OF BEW 3.50 3.50 PACKAGE. (REFER TO DCE JOB 0.60 NUMBER 1870) -----3.33% 3.33% -3.33% DATUM RL18.000 DESIGN SURFACE 20.153 20.151 20.153 20.151 BEW SURFACE ______ EXISTING SURFACE OFFSET CH 45.310 — EXISTING STOCKPILE TO BE -----------REMOVED AS PART OF BEW PACKAGE. (REFER TO DCE JOB NUMBER 1870) EXISTING STOCKPILE TO BE REMOVED AS PART OF BEW 16.00 7.00 2.95 2.95 1.50 PACKAGE. (REFER TO DCE JOB 7.00 2.95 1.50 3.50 3.50 NUMBER 1870) 3.50 3.50 0.05 -----3.33% 3.33% 3.33% -3.33% -3.33% DATUM RL18.000 DATUM RL18.000 DESIGN SURFACE DESIGN SURFACE BEW SURFACE BEW SURFACE 23.54 23.538 EXISTING SURFACE EXISTING SURFACE OFFSET OFFSET CH 34.810 CH 55.810 BATCHELOR STREET R.GUTIERREZ

LEGEND

SUBBASE

AG DRAIN

CONCRETE

TOPSOIL & SEED

STRUCTURAL FILL

CAPPING/CONSTRUCTION LAYER

---- EXISTING SURFACE

FINISHED SURFACE

----- BEW SURFACE

Date

Date

30/11/22 PN/SR TL

17/11/22 GA TL

21/09/22 PN/RG TL

14/09/22 PN/NR TL Date

14/09/22 3401095

13/09/22

3791018

21/09/22

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2951057

Designed P.NICHOLSON

Checked S.RAJKOVIC

NOTE: TYPE A STRUCTURAL FILL

NOTE: BULK EARTHWORKS (BEW)

RIVERWALK

CROSS SECTIONS

SHEET 08 OF 10

Sheet No. 27 of 40

GEELONG ROAD, WERRIBEE

Rev D

WYNDHAM CITY COUNCIL

Drawing No. 10940XS08

STAGE 40

Coords: MGA Levels: AHD

www.byda.com.au

Scale @ A1/A3

H1:100/200 V1:50/100

TYPE A STRUCTURAL FILL MATERIAL IN ACCORDANCE WITH THE REQUIREMENTS OF TABLE 201.10Q OF THE WYNDHAM CITY COUNCIL SUBDIVISION GUIDELINES AND SHALL BE FREE OF TOPSOIL, DELETERIOUS MATERIAL AND PERISHABLE MATTER. ALL FILL AREAS MUST ENSURE LEVEL 1 SUPERVISION IS MAINTAINED PER AS3798-2007

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CONSTRUCTION

Written dimensions to take precedence over scale. Contractor shall check and verify all dimensions on site. Discrepancies to be brought to the attention of the Superintendent.

D | COUNCIL COMMENTS 29/11/22

C COUNCIL COMMENTS 24/10/22


B | COUNCIL ISSUE

트등 할 A TENDER ISSUE

REV DESCRIPTION

NOTE: TYPE A STRUCTURAL FILL TYPE A STRUCTURAL FILL MATERIAL IN ACCORDANCE WITH THE REQUIREMENTS OF TABLE 201.10Q OF THE WYNDHAM CITY COUNCIL SUBDIVISION GUIDELINES AND SHALL BE FREE OF TOPSOIL, DELETERIOUS MATERIAL AND PERISHABLE MATTER. ALL FILL AREAS MUST ENSURE LEVEL 1 SUPERVISION IS MAINTAINED PER AS3798-2007

NOTE: ALL OTHER FILL FILLING COMPACTED TO AS3798-2007 LEVEL 1 REQUIREMENTS WITH APPROVED FILL MATERIAL

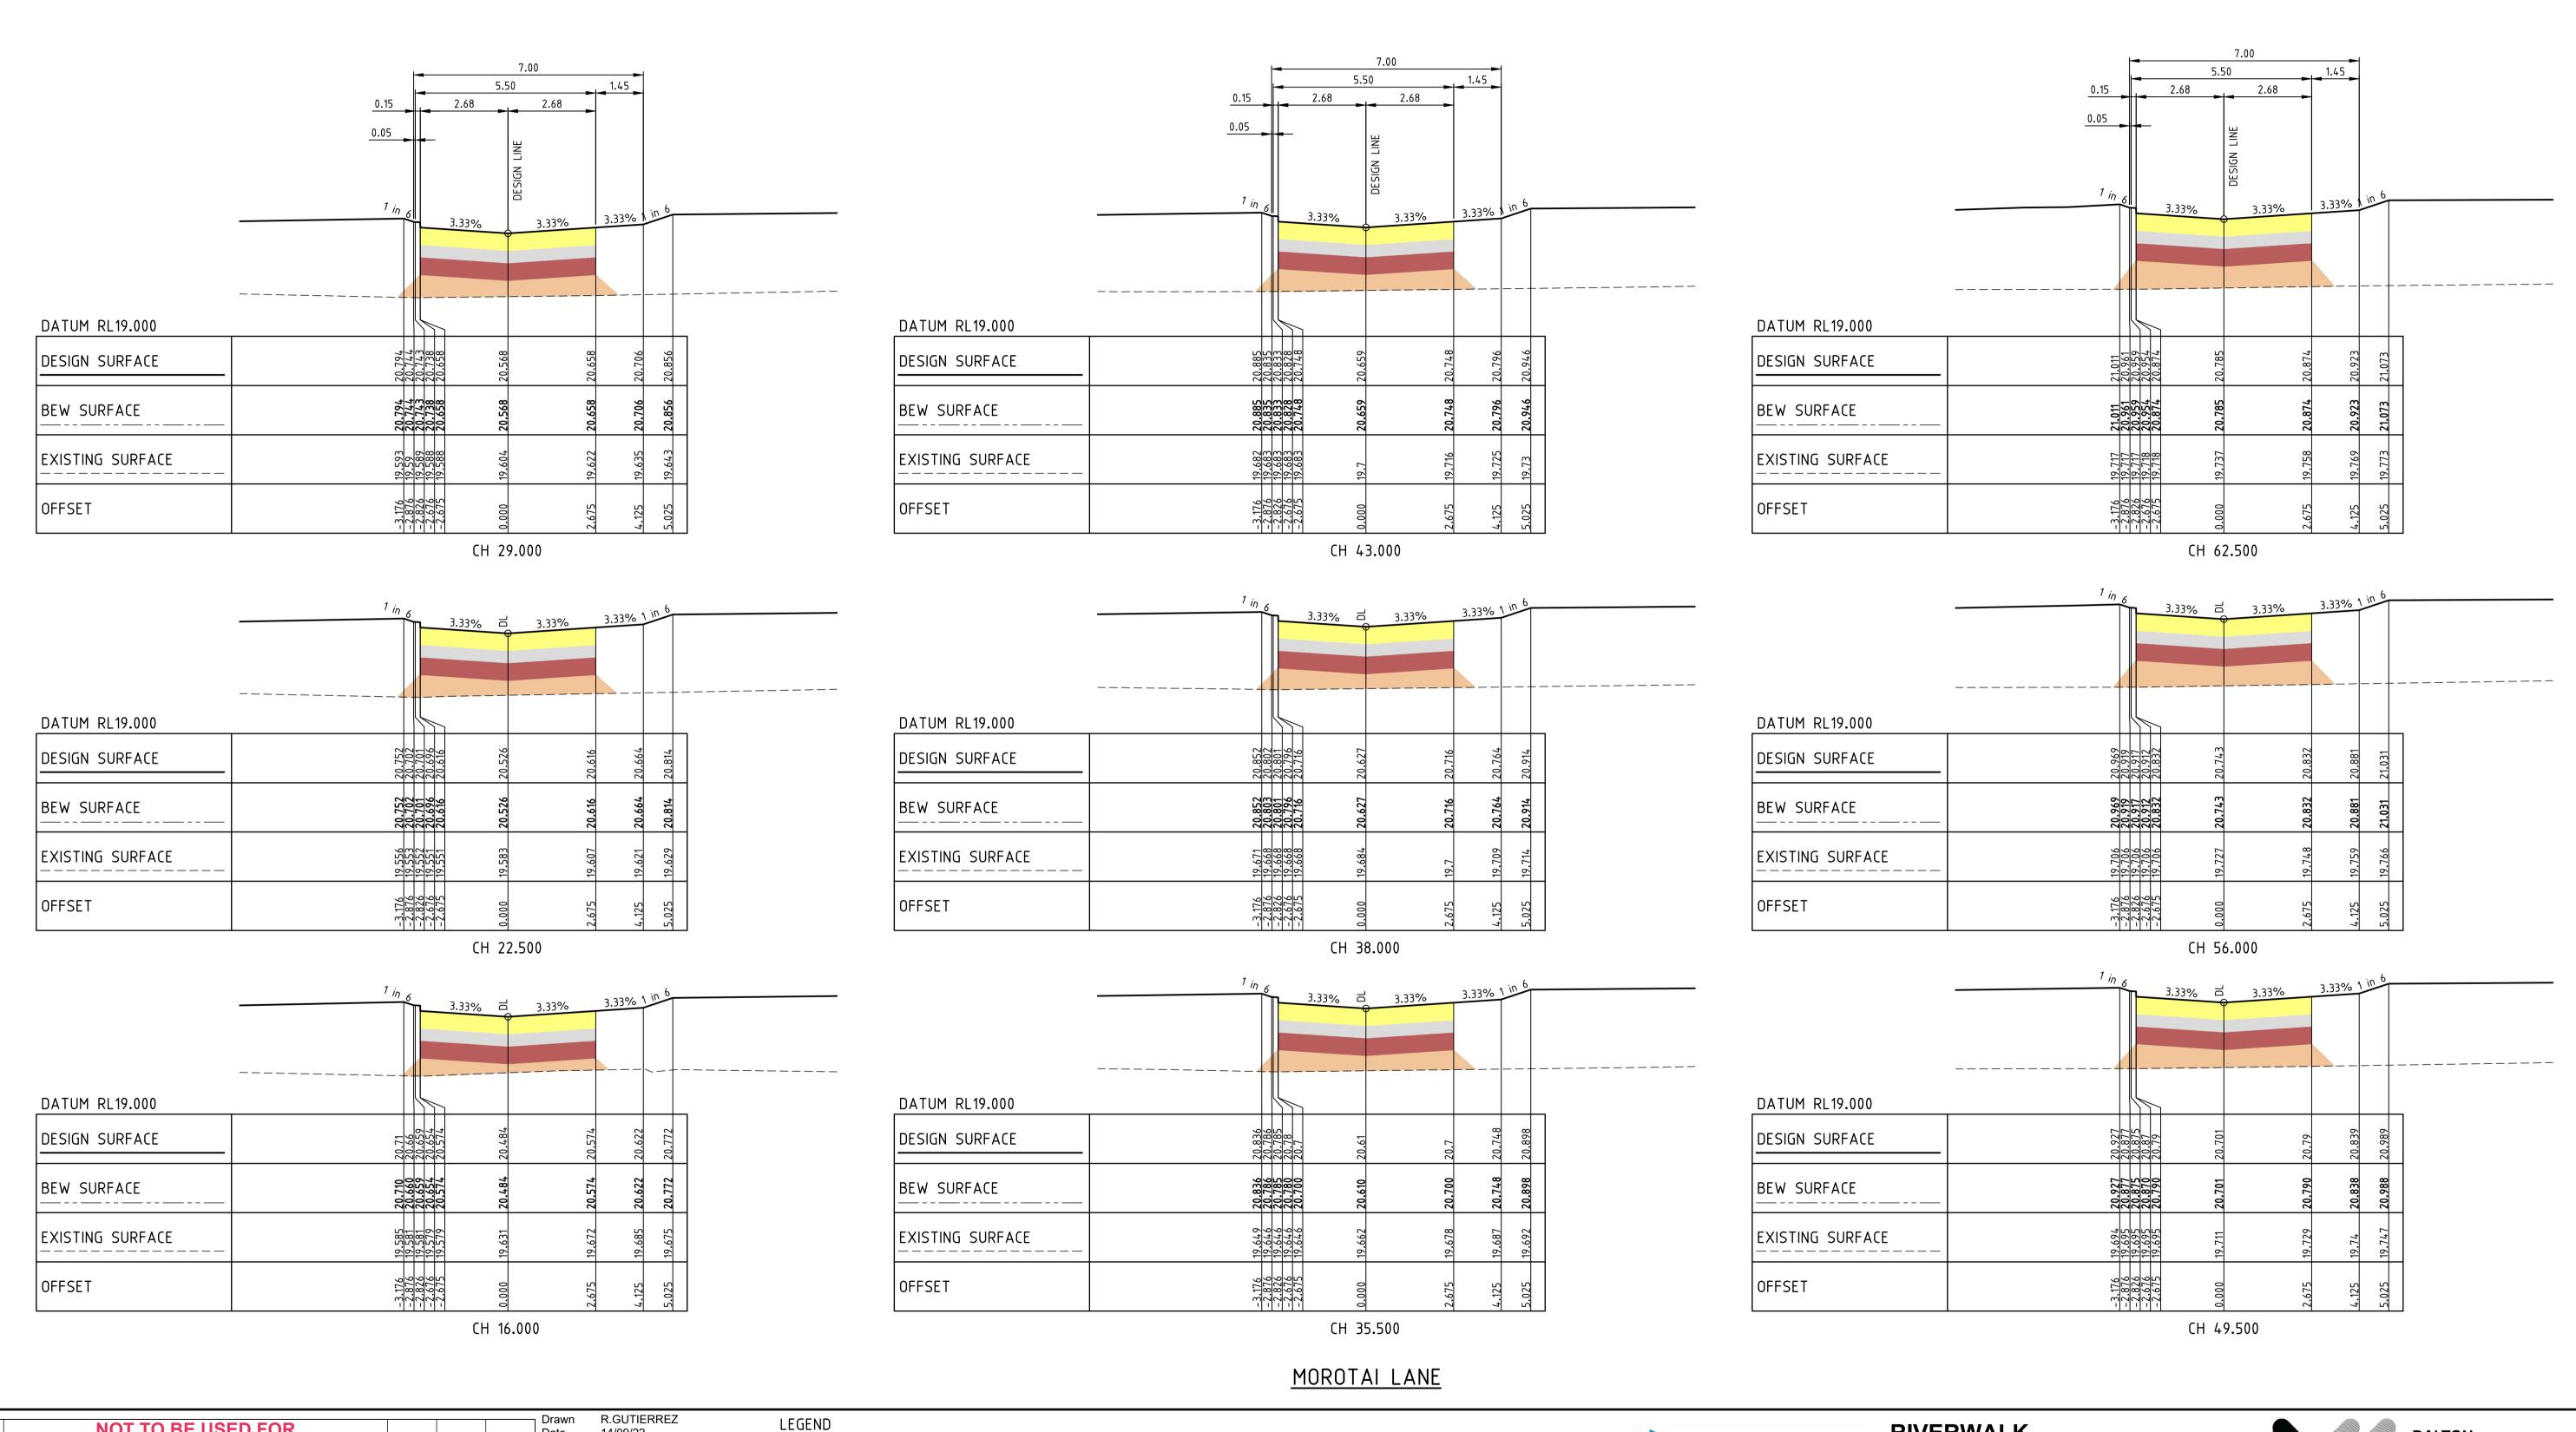

NOT TO BE USED FOR Date 14/09/22 3401095 CONSTRUCTION ---- EXISTING SURFACE Designed P.NICHOLSON FINISHED SURFACE 13/09/22 ----- BEW SURFACE SUBBASE 3791018 CAPPING/CONSTRUCTION LAYER D COUNCIL COMMENTS 29/11/22 30/11/22 PN/SR TL Checked S.RAJKOVIC Date 21/09/22 17/11/22 GA C COUNCIL COMMENTS 24/10/22 TL AG DRAIN 2951057 B COUNCIL ISSUE 21/09/22 PN/RG TL CONCRETE Approved 14/09/22 PN/NR TL Date 트등 할 A TENDER ISSUE TOPSOIL & SEED DATE AMEND APP'D AN

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STRUCTURAL FILL

REV DESCRIPTION

Written dimensions to take precedence over scale. Contractor shall check and verify all dimensions on site. Discrepancies to be brought to the attention of the Superintendent.





H1:100/200 V1:50/100

RIVERWALK STAGE 40 GEELONG ROAD, WERRIBEE WYNDHAM CITY COUNCIL **CROSS SECTIONS SHEET 09 OF 10 Drawing No. 10940XS09**

Sheet No. 28 of 40


Rev D



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FINISHED SURFACE

----- BEW SURFACE

SUBBASE

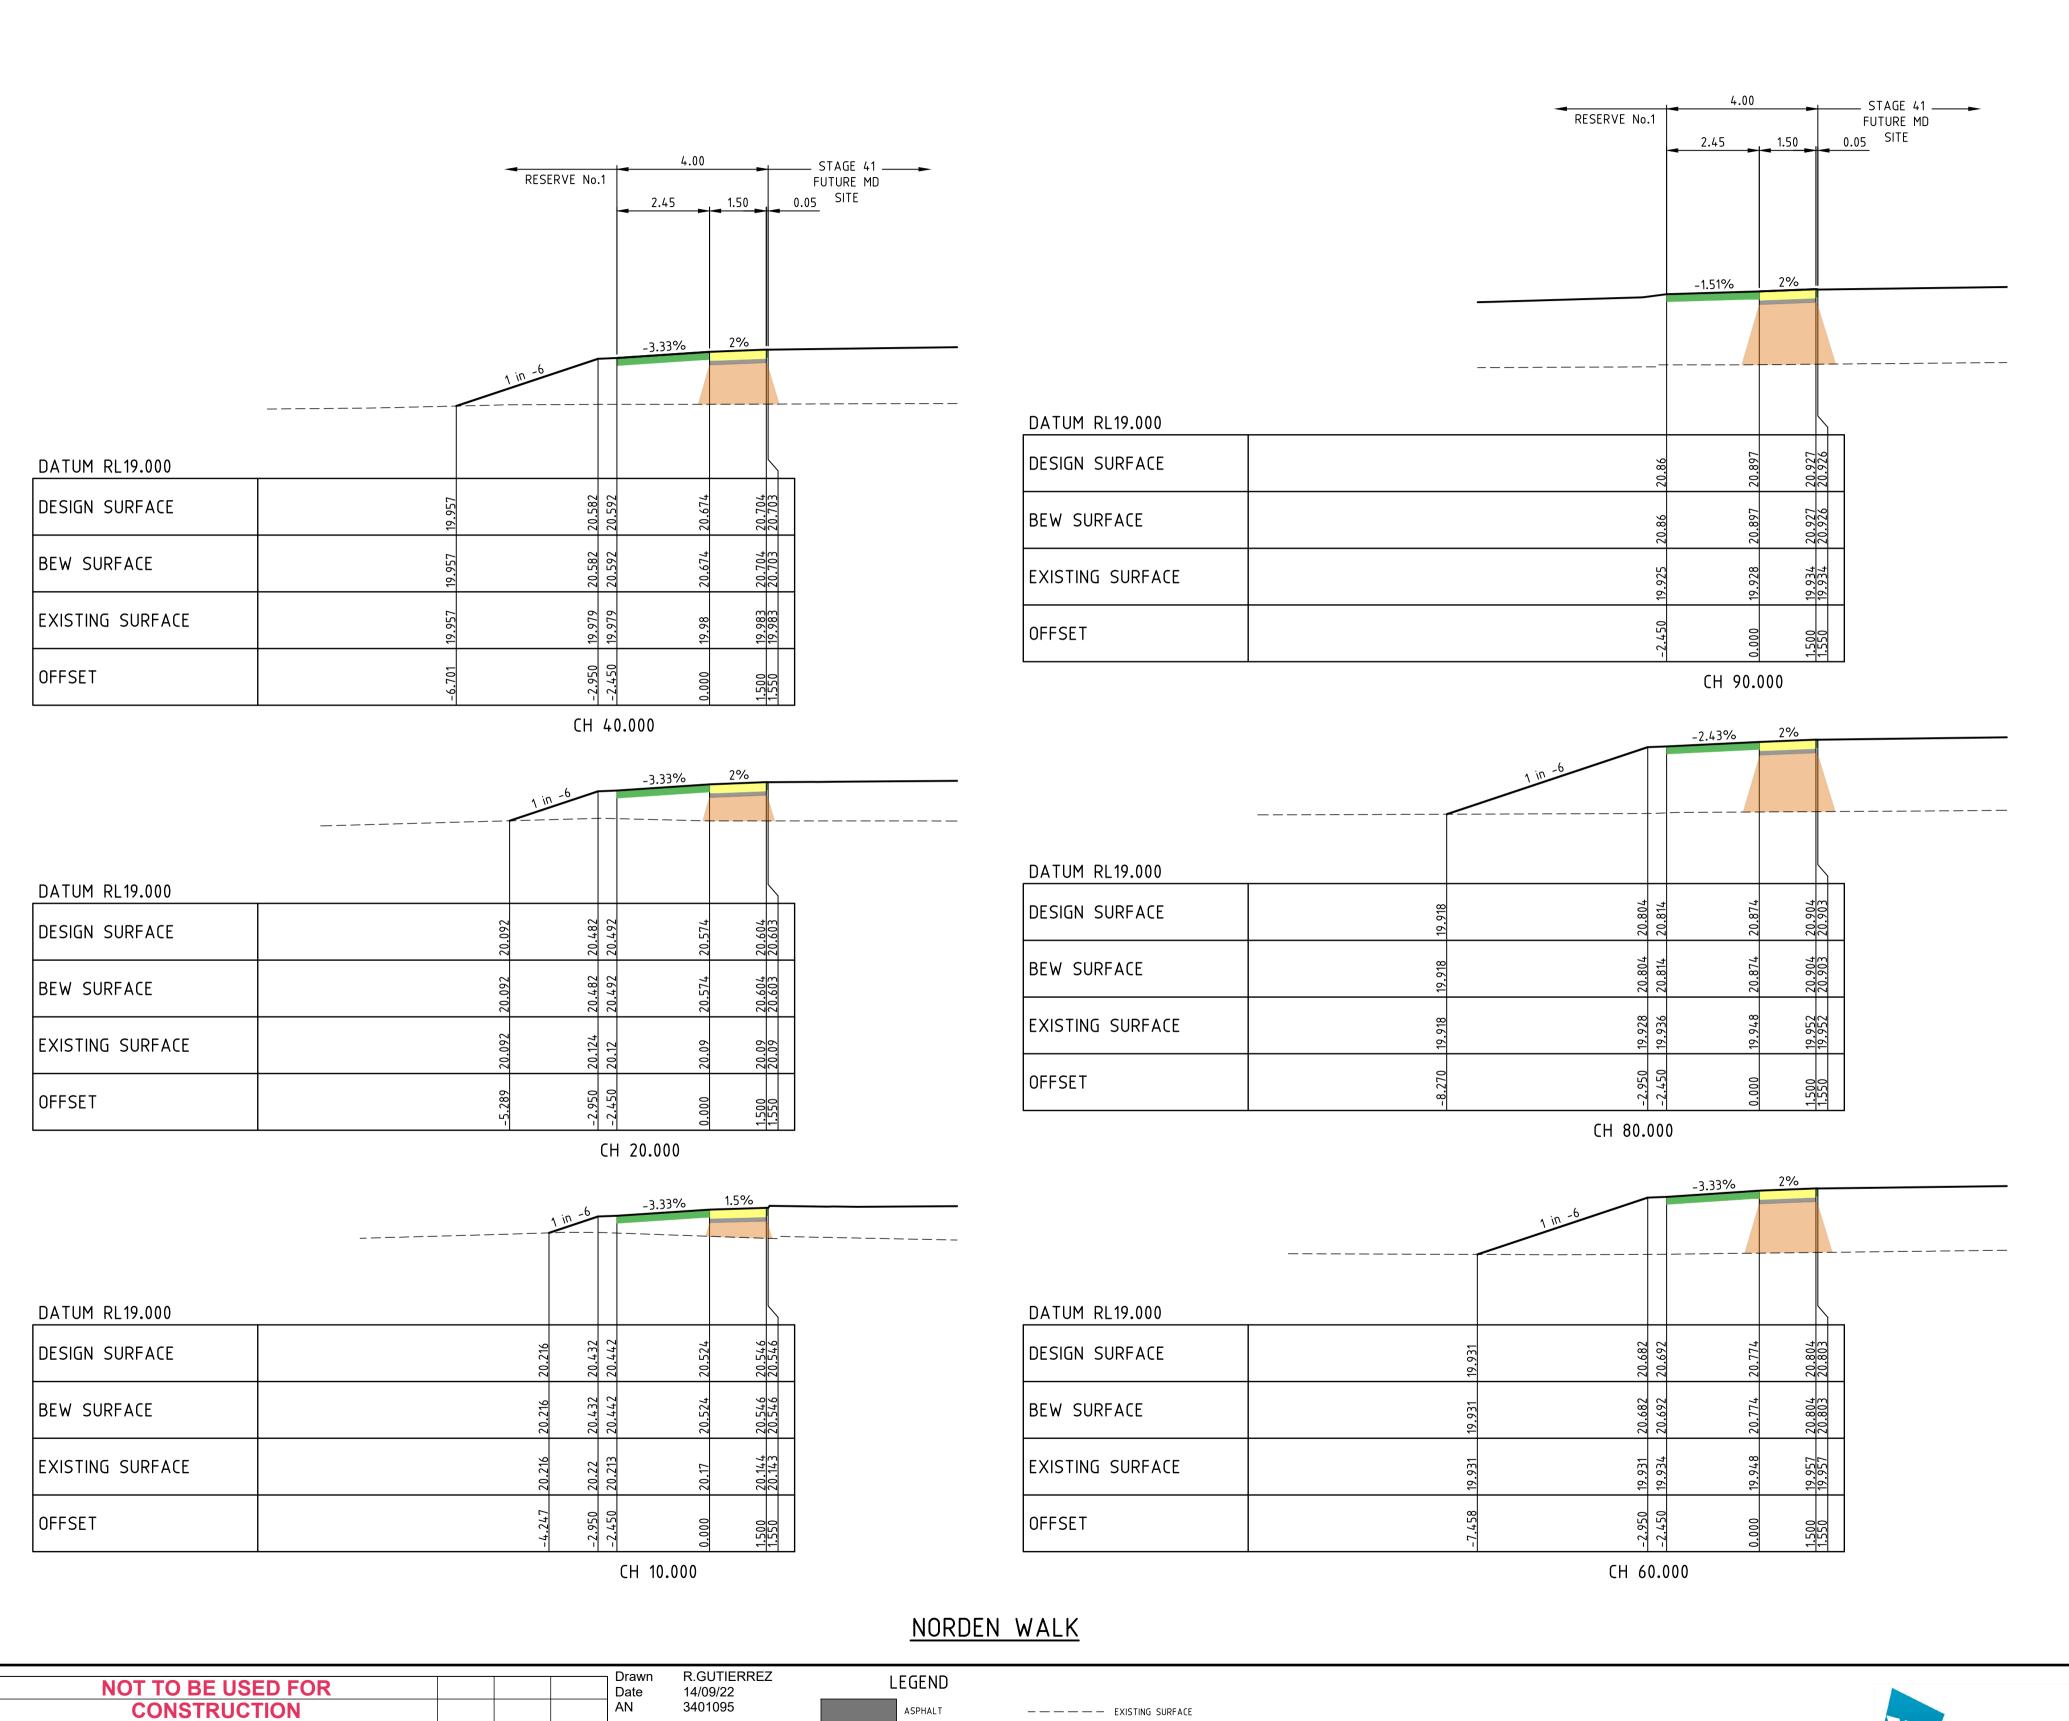AG DRAIN

CONCRETE

TOPSOIL & SEED

STRUCTURAL FILL

CAPPING/CONSTRUCTION LAYER

Designed P.NICHOLSON

Checked S.RAJKOVIC

Date

Date

TL

30/11/22 PN/SR TL

21/09/22 PN/RG TL

14/09/22 PN/NR TL Date

17/11/22 GA

D | COUNCIL COMMENTS 29/11/22

Written dimensions to take precedence over scale. Contractor shall check and verify all dimensions on site. Discrepancies to be brought to the attention of the Superintendent.

 $\mathbb{Z} \stackrel{\times}{\longrightarrow} \mathbb{Z}$ C COUNCIL COMMENTS 24/10/22

COUNCIL ISSUE

REV DESCRIPTION

13/09/22

3791018

21/09/22

2951057

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NOTE: TYPE A STRUCTURAL FILL

TYPE A STRUCTURAL FILL MATERIAL IN ACCORDANCE WITH THE REQUIREMENTS OF TABLE 201.10Q OF THE WYNDHAM CITY COUNCIL SUBDIVISION GUIDELINES AND SHALL BE FREE OF TOPSOIL, DELETERIOUS MATERIAL AND PERISHABLE MATTER. ALL FILL AREAS MUST ENSURE LEVEL 1 SUPERVISION IS MAINTAINED PER AS3798-2007

NOTE: BULK EARTHWORKS (BEW)

FILL TO BE COMPLETED AS PART OF PERMIT 11 BULK EARTHWORKS PACKAGE WHICH IS TO BE COMPLETED PRIOR TO SUBDIVISIONAL CIVIL WORKS (REFER TO DCE PROJECT REFERENCE NUMBER 10870)

NOTE: ALL OTHER FILL

FILLING COMPACTED TO AS3798-2007 LEVEL 1 REQUIREMENTS

WITH APPROVED FILL MATERIAL


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Rev D


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PRELIMINARY



RIVERWALK

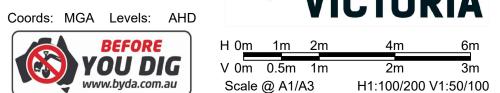

Designed P.NICHOLSON Date 13/09/22 3791018 D COUNCIL COMMENTS 29/11/22 30/11/22 PN/SR TL Checked S.RAJKOVIC Date 21/09/22 C COUNCIL COMMENTS 24/10/22 17/11/22 GA ----- HYDRAULIC GRADE LINE 2951057 CRUSHED ROCK BACKFILL B COUNCIL ISSUE 21/09/22 PN/RG TL 14/09/22 PN/NR TL Date 투 등 별 A TENDER ISSUE REV DESCRIPTION DATE AMEND APP'D AN
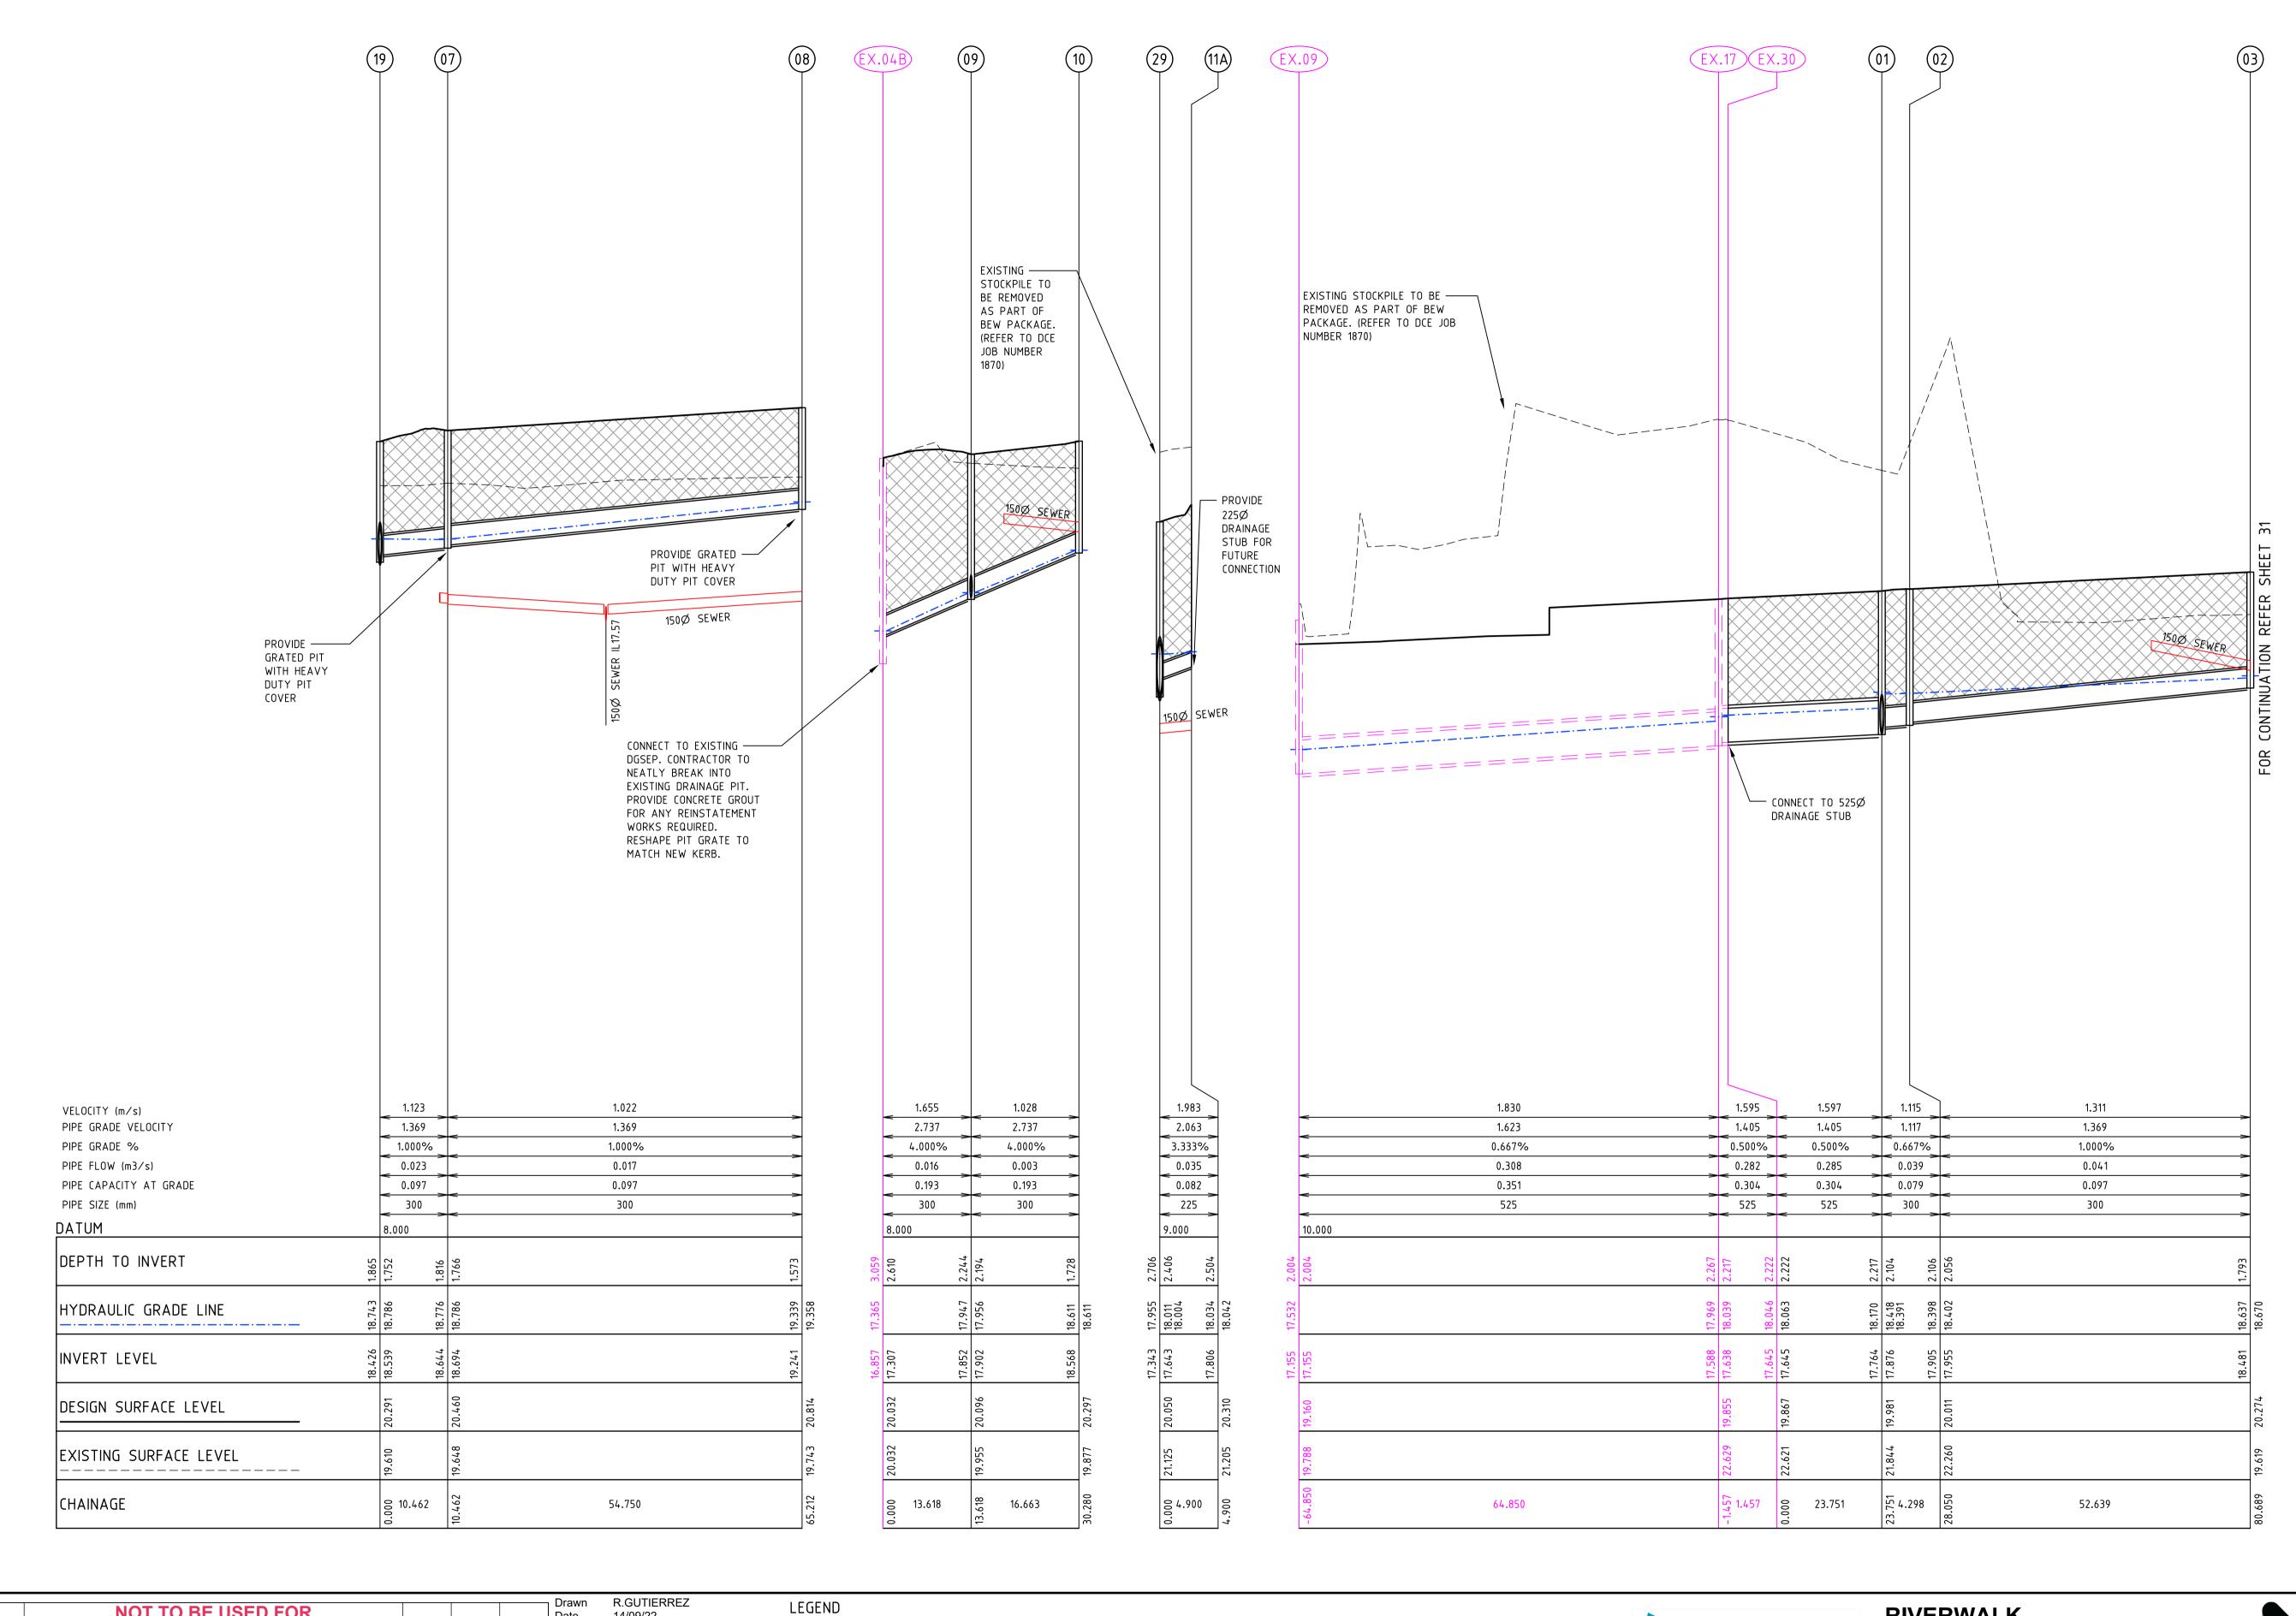
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14/09/22

3401095

---- EXISTING SURFACE

NOT TO BE USED FOR

CONSTRUCTION

Written dimensions to take precedence over scale. Contractor shall check and verify all dimensions on site. Discrepancies to be brought to the attention of the Superintendent.






Scale @ A1/A3 H1:500/1000 V1:50/100

RIVERWALK STAGE 40 **GEELONG ROAD, WERRIBEE** WYNDHAM CITY COUNCIL DRAINAGE LONGITUDINAL SECTIONS **SHEET 01 OF 03** Drawing No. 10940DR01 Rev D

Sheet No. 30 of 40



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NOT TO BE USED FOR Date AN CONSTRUCTION Date D COUNCIL COMMENTS 29/11/22 30/11/22 PN/SR TL Date 17/11/22 GA C COUNCIL COMMENTS 24/10/22 21/09/22 PN/RG TL B | COUNCIL ISSUE 14/09/22 PN/NR TL Date 트등 je A TENDER ISSUE REV DESCRIPTION

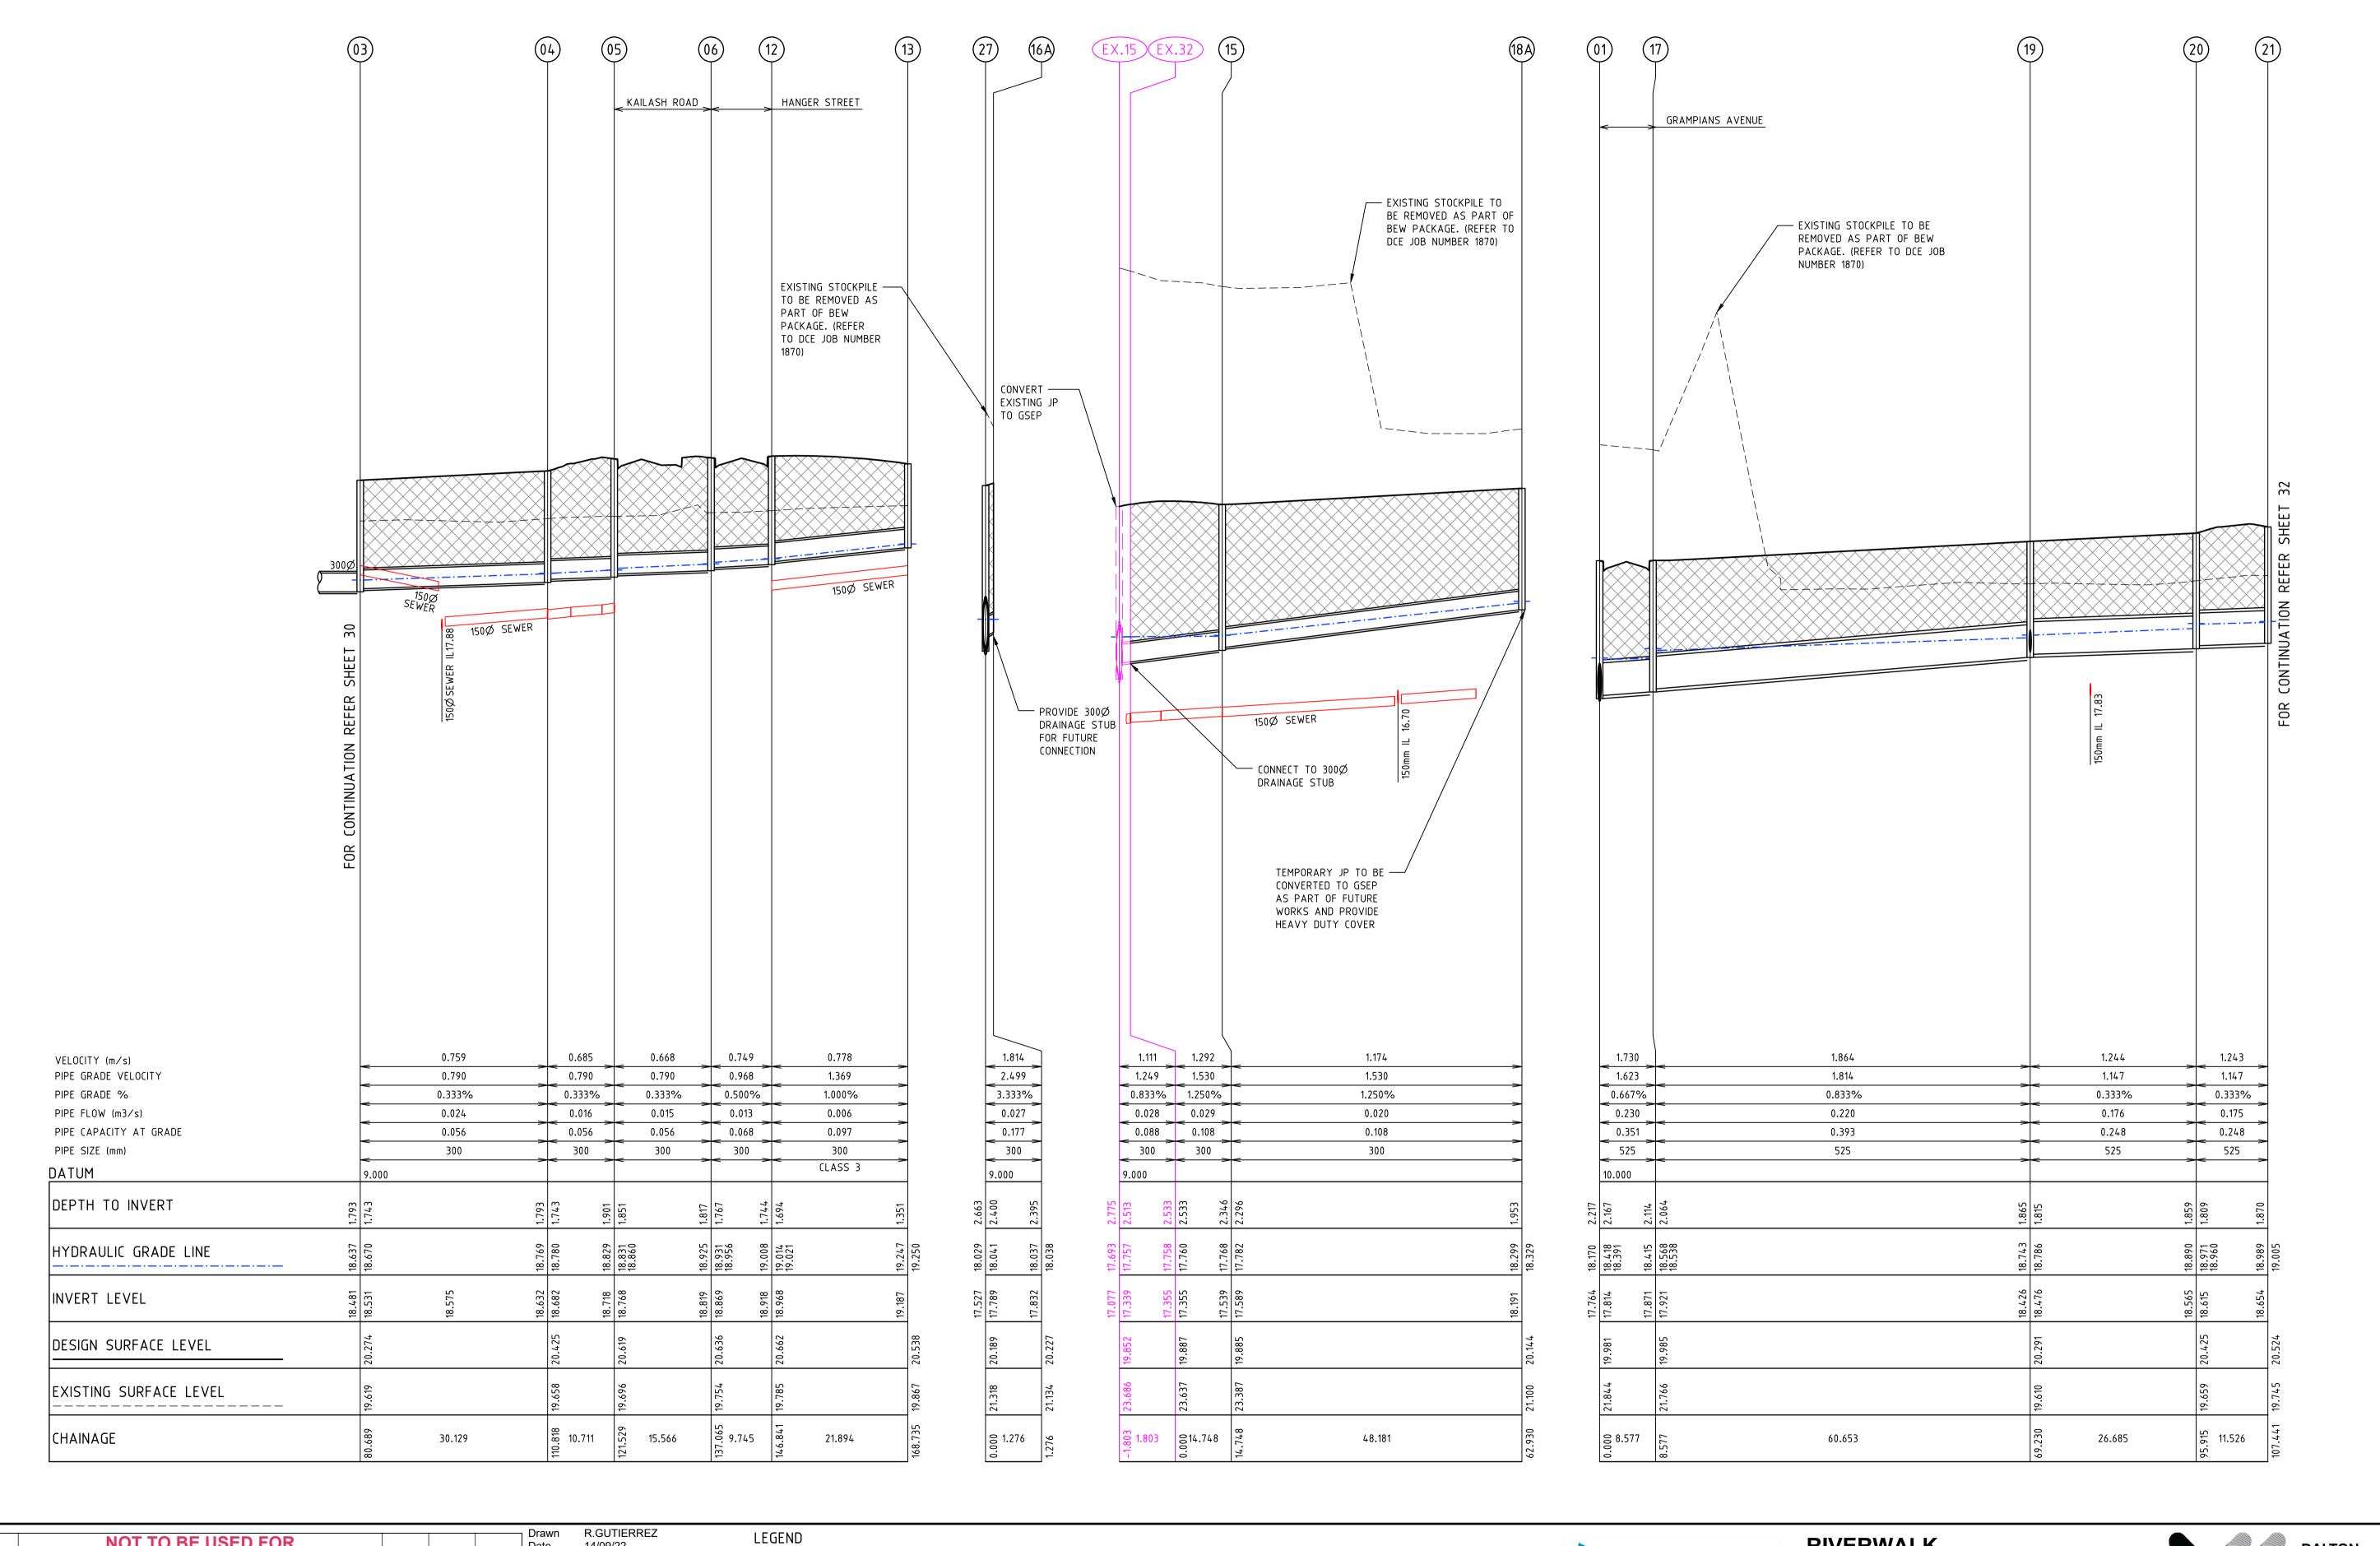Written dimensions to take precedence over scale. Contractor shall check and verify all dimensions on site. Discrepancies to be brought to the attention of the Superintendent.

14/09/22 3401095 Designed P.NICHOLSON 13/09/22 3791018 Checked S.RAJKOVIC 21/09/22 2951057

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DATE AMEND APP'D AN

---- EXISTING SURFACE FINISHED SURFACE ----- HYDRAULIC GRADE LINE CRUSHED ROCK BACKFILL



Scale @ A1/A3 H1:500/1000 V1:50/100




Sheet No. 31 of 40

RIVERWALK GEELONG ROAD, WERRIBEE WYNDHAM CITY COUNCIL DRAINAGE LONGITUDINAL SECTIONS Drawing No. 10940DR02 Rev D



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Written dimensions to take precedence over scale. Contractor shall check and verify all dimensions on site. Discrepancies to be brought to the attention of the Superintendent.

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LEGEND ---- EXISTING SURFACE ----- HYDRAULIC GRADE LINE CRUSHED ROCK BACKFILL

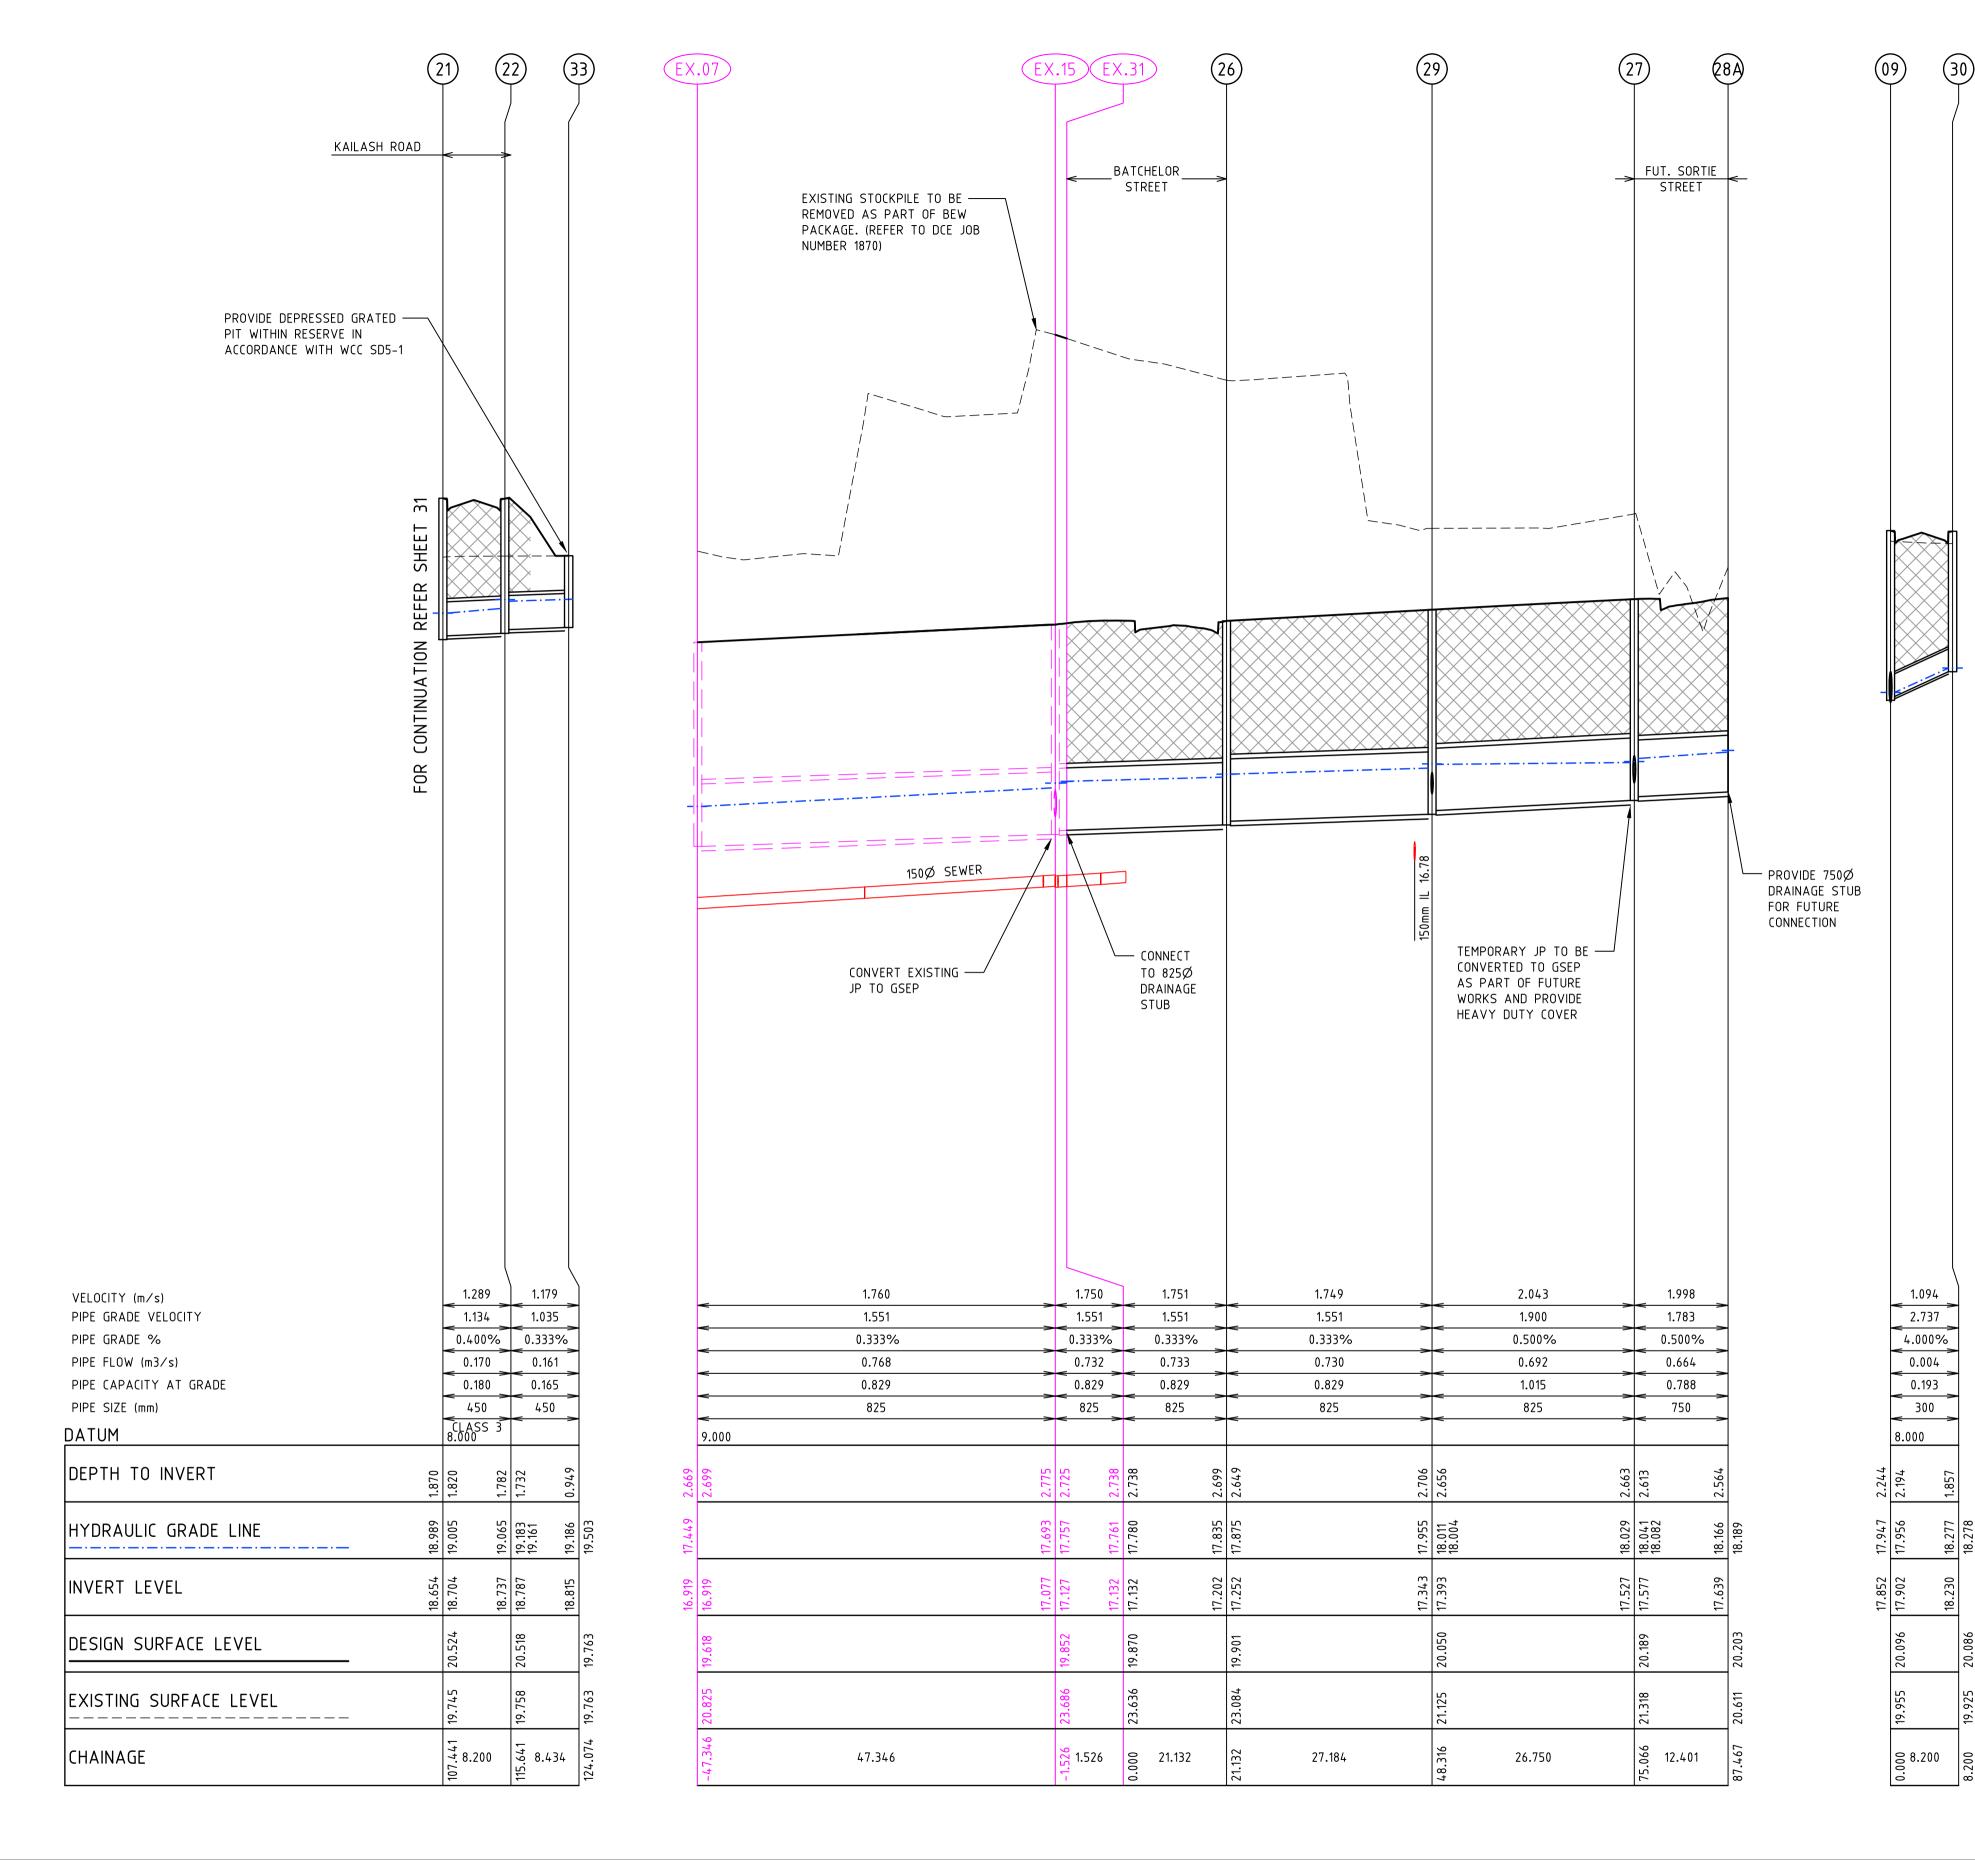

Scale @ A1/A3 H1:500/1000 V1:50/100

RIVERWALK STAGE 40 **GEELONG ROAD, WERRIBEE** WYNDHAM CITY COUNCIL DRAINAGE LONGITUDINAL SECTIONS **SHEET 03 OF 03** Drawing No. 10940DR03 Rev D


Sheet No. 32 of 40




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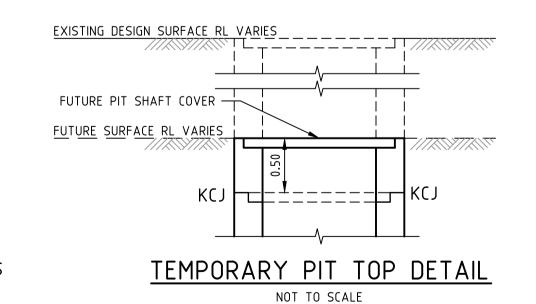
| | PIT SCHEDULE | | | | | | | | | | | | | | | | | |
|-------------|--------------|--------------------------|----------------------------|--------------|---------------|---------------|----------------|---------------|------------------|----------------|-------------------|------------------|----------------|----------------------|------------------|----------------------|---------------|---|
| PIT NAME | PIT TYPE | PIT EASTING | PIT NORTHING | LID WIDTH | LID LENGTH | BASE WIDTH | BASE LENGTH | INLET DIA. | INLET INV LEV | OUTLET DIA. | OUTLET INV LEV | PIT SETOUT RL | PIT DEPTH | PIT DETAIL | HAUNCH DETAIL | STEP IRONS | HEAVY DUTY | FURTHER COMMENTS |
| 7 | GP | 293172.313 | 5801585.722 | 600 | 900 | 600 | 900 | 300 | 18.694 | 300 | 18.644 | 20.460 | 1.816 | EDCM 601 | - | EDCM 609 | YES | PROVIDE GRATED PIT WITH HEAVY DUTY PIT COVER |
| 8 | GP | 293125.129 | 5801613.494 | 600 | 900 | 600 | 900 | | | 300 | 19.241 | 20.814 | 1.573 | EDCM 601 | - | EDCM 609 | YES | PROVIDE GRATED PIT WITH HEAVY DUTY PIT COVER |
| EX 04B | DGSEP | 293277.721 | 5801643.677 | 600 | 900 | 1100 | 900 | 300 | 17.307 | | | 20.032 | 3.175 | EDCM 602 | EDCM 607 | EDCM 609 | | CONNECT TO EXISTING DGSEP. CONTRACTOR TO NEATLY BREAK INTO EXISTING DRAINAGE PIT. PROVIDE CONCRETE GROUT FOR ANY REINSTATEMENT WORKS REQUIRED. RESHAPE PIT GRATE TO MATCH NEW KERB. |
| 9 | GSEP | 293264.109 | 5801643.285 | 600 | 900 | 600 | 900 | 300 300 | 17.902 17.902 | 300 | 17.852 | 20.096 | 2.244 | EDCM 601 | - | EDCM 609 | | |
| 10 | JP | 293252.553 | 5801631.280 | 600 | 900 | 600 | 900 | | | 300 | 18.568 | 20.297 | 1.728 | EDCM 605 | _ | EDCM 609 | | |
| 11A | EP | 293110.343 | 5801533.174 | | | | | | | 225 | 17.806 | 20.310 | 2.504 | - | - | - | | PROVIDE 225mm DRAINAGE STUB FOR FUTURE CONNECTION |
| EX 17 | GSEP | 293150.363 | | 600 | 900 | 900 | 900 | 525 | 17.638 | 525 | 17.588 | 19.855 | 2.267 | EDCM 601 | - | EDCM 609 | | CONVERT EXISTING JP TO GSEP |
| EX 30 | EP | 293150.676 | 5801495.757 | | | | | 525 | 17.645 | 525 | 17.645 | 19.867 | 2.222 | | | | | CONNECT TO 525mm DRAINAGE STUB |
| 1 | GSEP | 293153.26 | 5801519.367 | 600 | 900 | 750 | 900 | 300 | 17.876 | 525 | 17.764 | 19.981 | 2.217 | EDCM 605 | | EDCM 609 | | |
| | | | | | | | | 525 | 17.814 | | | | | | | | | |
| 2 | JP | 293154.627 | 5801523.442 | 600 | 900 | 600 | 900 | 300 | 17.955 | 300 | 17.905 | 20.011 | 2.106 | EDCM 601 | - | EDCM 609 | | |
| 3 | GSEP | 293181.328 | 5801568.807 | 600 | 900 | 600 | 900 | 300 | 18.531 | 300 | 18.481 | 20.274 | 1.793 | EDCM 601 | - | EDCM 609 | | |
| 4 | GSEP | 293196.611 | 5801594.772 | 600 | 900 | 600 | 900 | 300 | 18.682 | 300 | 18.632 | 20.425 | 1.793 | EDCM 601 | - | EDCM 609 | | |
| 5 | GSEP | 293206.735 | 5801598.270 | 600 | 900 | 600 | 900 | 300 | 18.768 | 300 | 18.718 | 20.619 | 1.901 | EDCM 601 | - | EDCM 609 | | |
| 6 | GSEP | 293218.829 | 5801608.07 | | | | | 300 | 18.869 | 300 | 18.819 | 20.636 | 1.817 | EDCM 601 | - | EDCM 609 | | |
| 12 | GSEP | 293228.389 | 5801606.177 | 600 | 900 | 600 | 900 | 300 | 18.968 | 300 | 18.918 | 20.662 | 1.744 | EDCM 601 | - | EDCM 609 | | |
| 13 | JP | 293243.572 | | 600 | 900 | 600 | 900 | | | 300 | 19.187 | 20.538 | 1.351 2.395 | EDCM 605 | - | EDCM 609 | | DDOV/DE 2002 DDAINA OF OTHE FOR FLITHER CONNECTION |
| 16A | EP EP | | 5801543.786 | | | | | 300 | 17.255 | 300 | 17.832 | 20.227 | 2.000 | - | - | - | | PROVIDE 300mm DRAINAGE STUB FOR FUTURE CONNECTION CONNECT TO 300mm DRAINAGE STUB |
| EX 32 | GSEP | | 5801496.155 5801506.479 | 600 | 900 | 600 | 900 | 300 | 17.355 17.589 | 300 300 | 17.355 17.539 | 19.887 19.885 | 2.533 2.346 | EDCM 601 | - | - EDCM 609 | | CONNECT TO 300mm DRAINAGE STOB |
| 18A | JP | 293130.093 | | 600 | 900 | 600 | 900 | 300 | 17.569 | 300 | 18.191 | 20.144 | 1.953 | EDCM 605 | - | EDCM 609 | YES | TEMPORARY JP TO BE CONVERTED TO GSEP AS PART OF FUTURE |
| 17 | JP | 293145.691 | 5801523.402 | 600 | 900 | 750 | 900 | 525 | 17.921 | 525 | 17.871 | 19.985 | 2.114 | FDCM 605 | FDCM 607 | EDCM 609 | | WORKS AND PROVIDE HEAVY DUTY COVER |
| 19 | GSEP | 293176.008 | 5801575.934 | 600 | 900 | 900 | 900 | 525 | 18.476 | 525 | 18.426 | 20.291 | 1.865 | | | EDCM 609 | | |
| | | | | | | | | 300 | 18.539 | | | | | | | | | |
| 20 | GSEP | 293189.545 | 5801598.931 | 600 | 900 | 1050 | 900 | 525 | 18.615 | 525 | 18.565 | 20.425 | 1.859 | EDCM 601 | EDCM 607 | EDCM 609 | | |
| 21 | DGSEP | 293186.655 | 5801610.089 | 600 | 900 | 1050 | 900 | 450 | 18.704 | 525 | 18.654 | 20.524 | 1.87 | EDCM 602 | EDCM 607 | EDCM 609 | | |
| 22 | DGSEP | 293190.815 | 5801617.156 | 600 | 900 | 600 | 900 | 450 | 18.787 | 450 | 18.737 | 20.518 | 1.782 | EDCM 602 | - | EDCM 609 | | |
| 33 | GP | 293192.329 | 5801625.452 | 750 | 1000 | 750 | 1000 | | | 450 | 18.815 | 19.763 | 0.949 | WCC SD5-1 | - | EDCM 609 | | PROVIDE DEPRESSED GRATED PIT TO CAPTURE RESERVE Q100 FLOWS. PIT TO BE SETOUT TO AVOID NEARBY TREES STRUCUTRAL ROOT SYSTEM |
| EX 15 | GSEP | 293142.222 | 5801495.319 | 600 | 900 | 1200 | 900 | 825 | 17.127 | 825 | 17.077 | 19.852 | 2.775 | EDCM 605 | EDCM 607 | EDCM 609 | | CONVERT EXISTING JP TO GSEP |
| | | | | | | | | 300 | 17.339 | | | | | | | | | |
| EX 31 | EP | 293141.424 | 5801496.671 | | | | | 825 | 17.132 | 825 | 17.132 | 19.87 | 2.738 | | - | | | CONNECT TO 750mm DRAINAGE STUB |
| 26 | GSEP | 293131.284 | | 600 | 900 | 1200 | 900 | 825 | 17.252 | 825 | 17.202 | 19.901 | 2.699 | | | EDCM 609 | | PROVIDE 300mm DRAINAGE STUB FOR Q5 OUTFLOW |
| 29 | GSEP | 293107.857 | 5801528.951 | 600 | 900 | 1050 | 900 | 825 | 17.393 | 825 | 17.343 | 20.05 | 2.706 | EDCM 601 | EDCM 607 | EDCM 609 | | |
| | | | | | | | | 225 | 17.643 | | /= | | | | | | | |
| 27 | JP | 293084.804 | 5801542.52 | 600 | 900 | 1050 | 900 | 750 | 17.577 | 825 | 17.527 | 20.189 | 2.663 | EDCM 605 | EDCM 607 | EDCM 609 | YES | TEMPORARY JP TO BE CONVERTED TO GSEP AS PART OF FUTURE |
| 20.4 | | 202074 000 | E904E40 040 | | | | | 300 | 17.789 | 750 | 47.000 | 20.202 | 2.504 | | | | | WORKS AND PROVIDE HEAVY DUTY COVER |
| 28A | EP | 293074.023 | 5801548.648 | 600 | 000 | 600 | 000 | | | 750 | 17.639 | 20.203 | 2.564 | EDCM 604 | | EDCM 600 | | PROVIDE 750mm DRAINAGE STUB FOR FUTURE CONNECTION |
| 30 EX 04 | GSEP GSEP | 293258.201 293236.005 | 5801648.972 5801573.276 | 600 600 | 900 | 600 600 | 900 | | | 300 300 | 18.23 18.855 | 20.086 20.645 | 1.857 1.789 | EDCM 601 EDCM 601 | - | EDCM 609 EDCM 609 | | CONVERT EXISTING JP TO GSEP |
| EX 04 | GSEP | | 5801573.276 | 600 | 900 | 600 | 900 | | | 300 | 18.816 | 20.550 | 1.789 | EDCM 601 | - | EDCM 609 | | CONVERT EXISTING JP TO GSEP CONVERT EXISTING JP TO GSEP |
| | GSEF | 293223.000 | 300 1333.378 | 000 | 900 | 000 | 900 | | | 300 | 10.010 | 20.000 | 1.734 | EDOM 001 | _ | EDOM 009 | | OUNVERT END HING OF TO GOEF |



PIT SETOUT POINT NOT TO SCALE

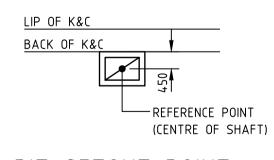

HAUNCHED PIT SETOUT POINT FOR HAUNCHED PITS WITH 150mm THICK WALLS NOT TO SCALE

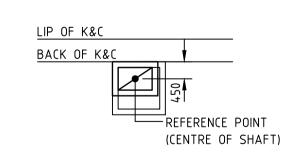

NOTES: DRAINAGE PITS

- EASTING, NORTHING SETOUT TO CENTRE OF PIT COVER. 2. SETOUT LEVEL TO PIT COVER LEVEL.
- . EASTING, NORTHING FOR ENDWALL SETOUT POINTS QUOTED TO PIPE INVERT CENTRELINE.
- ALL PIT COVERS TO BE IN ACCORDANCE WITH COUNCIL AND VPA REQUIREMENTS AND SPECIFICATIONS. ALL TEMPORARY JUNCTION PITS (JP) TO BE PROVIDED WITH KEYED CONSTRUCTION JOINTS (K.C.J) FOR FUTURE
- SEP CONVERSION. STEP IRONS REQUIRED FOR ALL PITS GREATER THAN
- 1000mm IN DEPTH.
- PIT FLOOR TO BE SHAPED TO MATCH LOWER HALF OF PIPE WHERE DROPS LESS THAN 50mm. ALL DRAINAGE WORKS ARE TO BE CONSTRUCTED AND EDCM TO VICTORIAN PLANNING AUTHORITY (VPA)
- SPECIFICATIONS. PIT BASE TO BE SHAPED WITH MASS CONCRETE FOR SMOOTH HYDRAULIC FLOW.
- ALL STORMWATER DRAINS ARE TO BE CLASS '2' RC UNLESS OTHERWISE SHOWN. ALL PIPES UP TO AND INCLUDING 750mm IN DIAMETER SHALL BE RUBBER RING JOINTED. PIPES ABOVE THIS SIZE MAY BE FLUSH JOINTED WITH EXTERNAL SEALING BANDS.
- I. ALL HAUNCHED PITS SHALL BE CONSTRUCTED IN ACCORDANCE WITH VPA REQUIREMENTS AND EDCM STD DRAWINGS.

NOTE: TEMPORARY TOPS

ALL PITS TO BE CONSTRUCTED WITH TEMPORARY TOPS, MATCHING TO EXISTING SURFACE FOR FUTURE GSEP/JP CONVERSION.

NOTE: STUBS

ALL STUBS FOR FUTURE EXTENSIONS TO BE SOCKETED UPSTREAM AND BLANKED OFF.

NOTE: SEDIMENT CONTROL

SEDIMENT CONTROL INCLUDING HAY BALES AND SEDIMENT TRAP FENCING IS REQUIRED FOR ALL OPEN EARTH DRAINS IN ACCORDANCE WITH EPA 'CONSTRUCTION TECHNIQUES FOR SEDIMENT POLLUTION CONTROL'. SEDIMENT CONTROL MEASURES TO BE MAINTAINED THROUGHOUT THE CONSTRUCTION AND MAINTENANCE PERIOD OF THE WORKS.

WARNING!


NO DRAINAGE WORKS SHALL COMMENCE UNTIL THE CONTRACTOR CONFIRMS THE I.L. OF ALL EXISTING DRAINS, AND CONFIRMS IN WRITING WITH THE ENGINEERING SUPERVISOR.

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|-------------|---|---------------------------------|----------|-------|-------|------------------------|------------------------------------|--|
| :39pmP | | NOT TO BE USED FOR CONSTRUCTION | | | | Drawn Date AN | R.GUTIERREZ 14/09/22 3401095 | |
| 2022 - 4: | | | | | | Designed Date AN | P.NICHOLSON 13/09/22 3791018 | |
| 30, | D | COUNCIL COMMENTS 29/11/22 | 30/11/22 | PN/SR | TL | Checked | S.RAJKOVIC | |
| Š | | COUNCIL COMMENTS 24/10/22 | 17/11/22 | GA | TL | Date | 21/09/22 | |
| Wed | | COUNCIL ISSUE | 21/09/22 | PN/RG | TL | Annroyad | 2951057 | |
| ime: | | TENDER ISSUE | 14/09/22 | PN/NR | TL | Approved Date | | |
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RIVERWALK STAGE 40 **GEELONG ROAD, WERRIBEE** WYNDHAM CITY COUNCIL PIT SCHEDULE






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E info@dceng.com.au

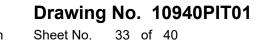



B | COUNCIL ISSUE 21/09/22 PN/RG 14/09/22 PN/NR TL Date A TENDER ISSUE DATE AMEND APP'D AN REV DESCRIPTION

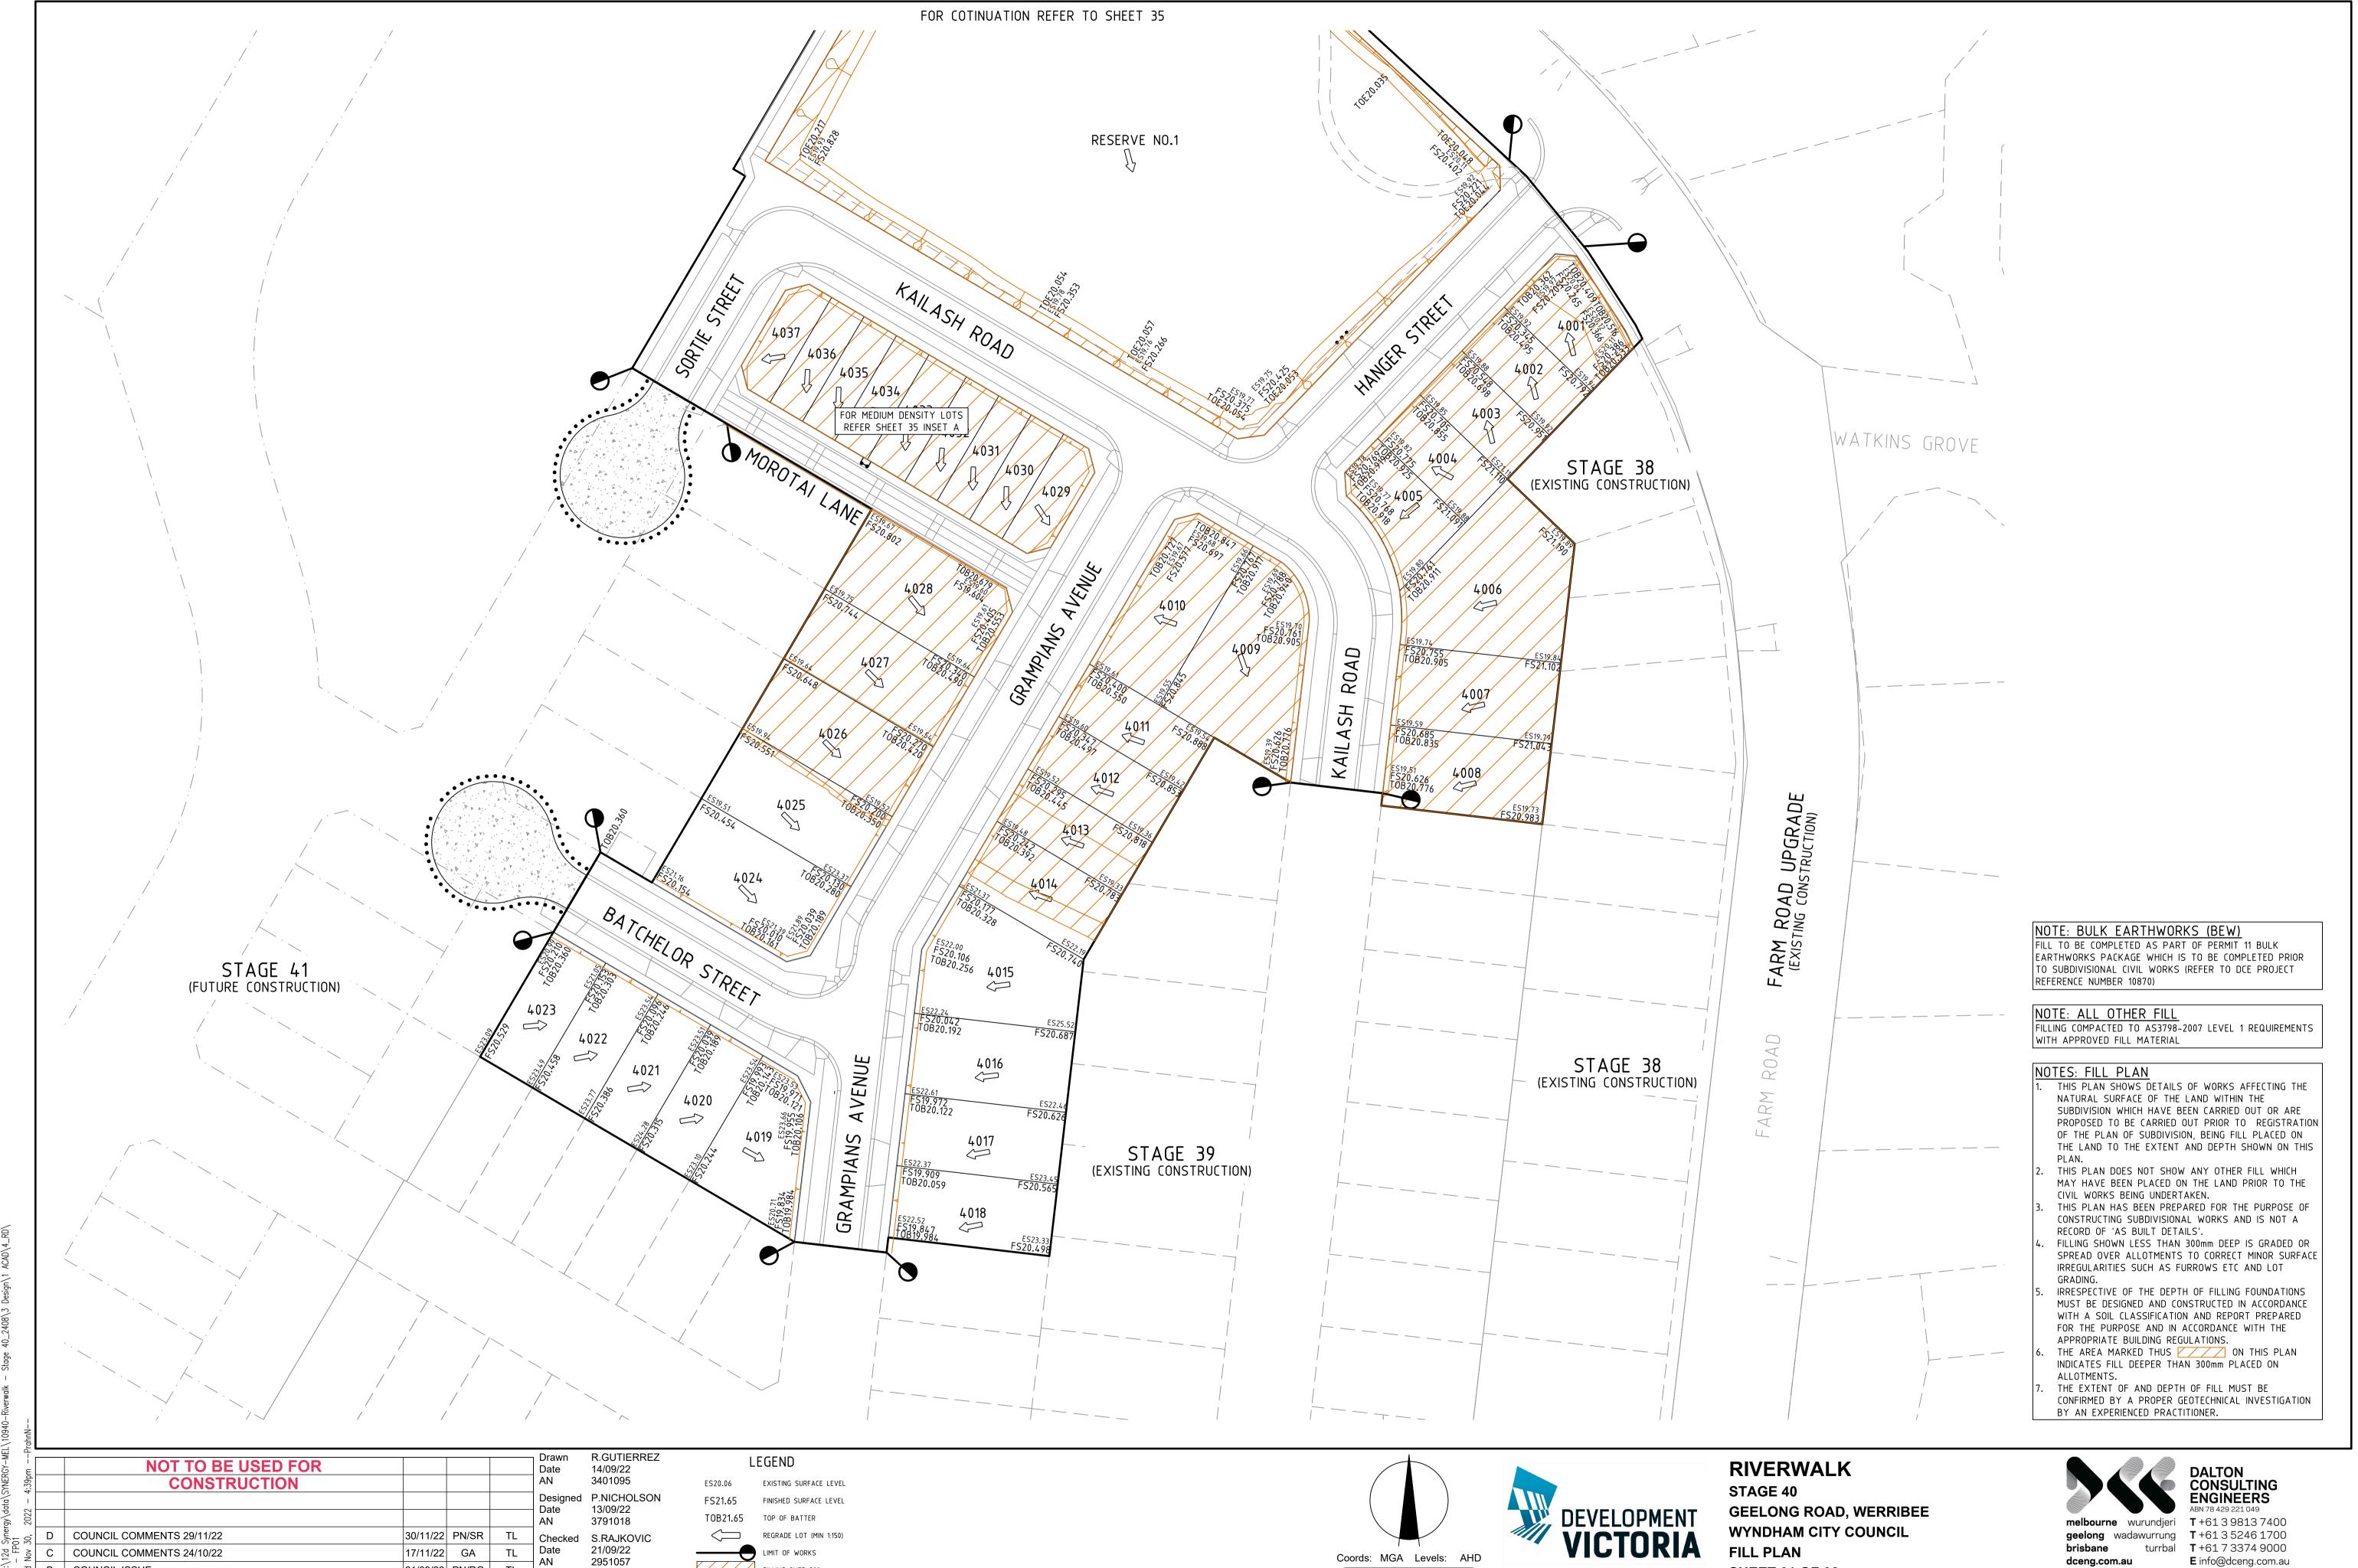Written dimensions to take precedence over scale. Contractor shall check and verify all dimensions on site. Discrepancies to be brought to the attention of the Superintendent.

2951057

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FILLING OVER 300mm - BATTER ---- ALLOTMENT PAD BOUNDARY






1:500 / 1:1000

SHEET 01 OF 02 Drawing No. 10940FP01

Sheet No. 34 of 40

Rev D

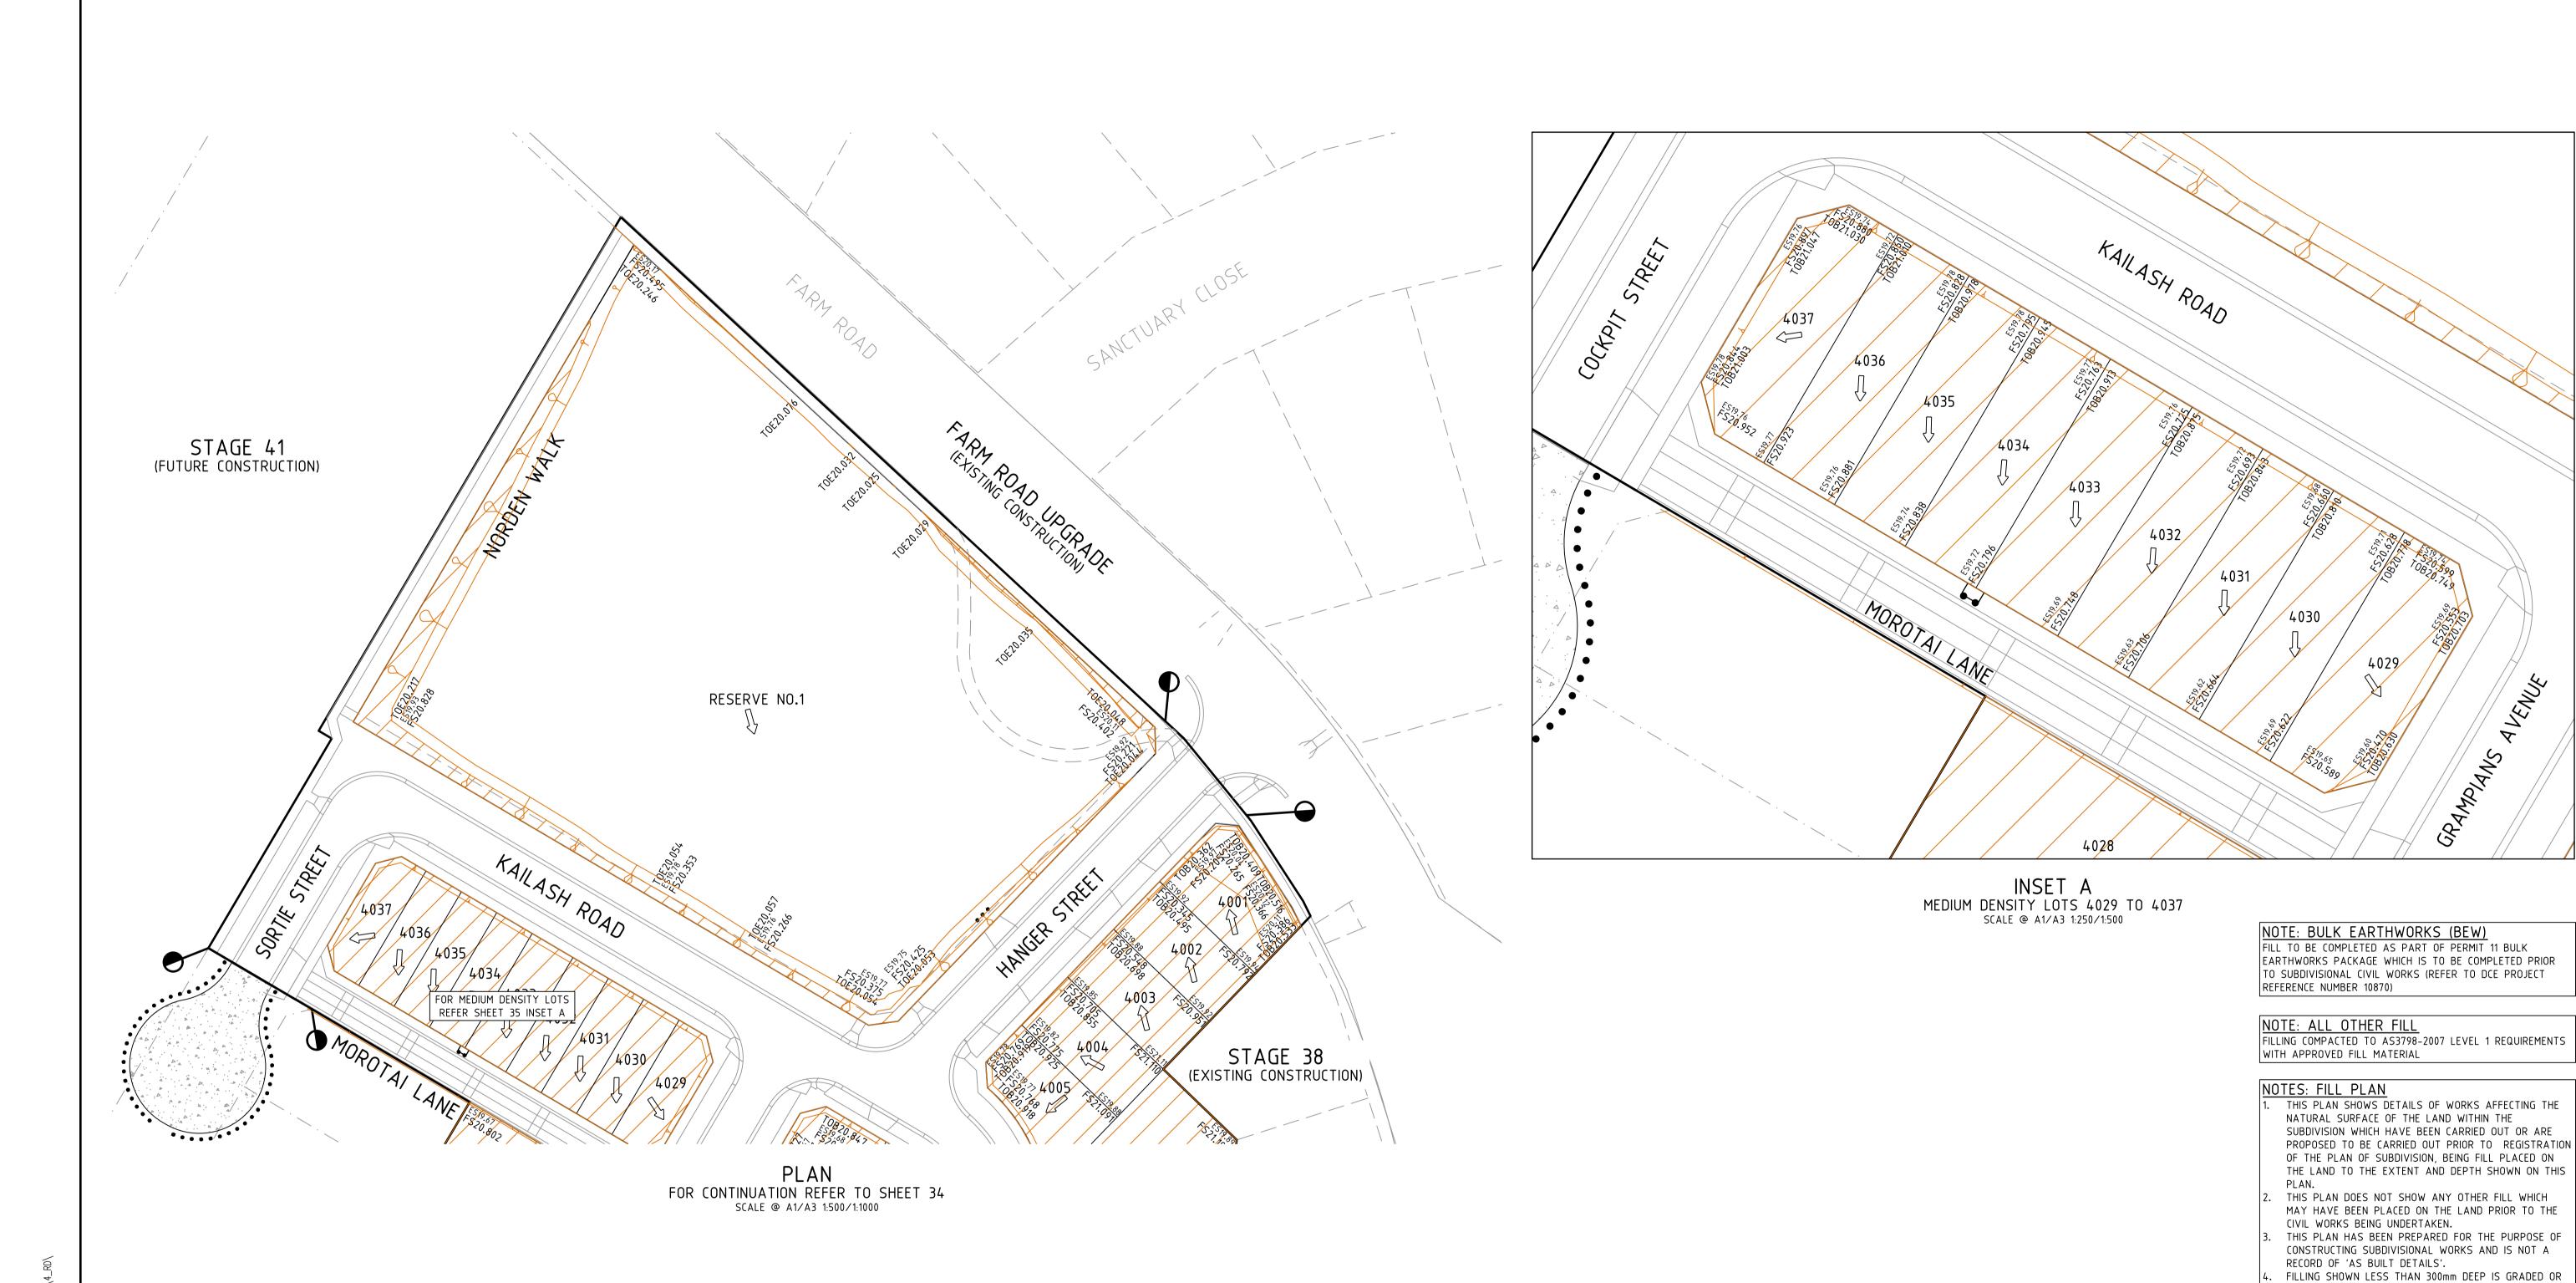

Scale @ A1/A3 1:500 / 1:1000 Sheet No. 35 of 40

RIVERWALK STAGE 40 **GEELONG ROAD, WERRIBEE** WYNDHAM CITY COUNCIL **FILL PLAN SHEET 02 OF 02** Drawing No. 10940FP02

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ALLOTMENTS.

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SPREAD OVER ALLOTMENTS TO CORRECT MINOR SURFACE IRREGULARITIES SUCH AS FURROWS ETC AND LOT

IRRESPECTIVE OF THE DEPTH OF FILLING FOUNDATIONS MUST BE DESIGNED AND CONSTRUCTED IN ACCORDANCE WITH A SOIL CLASSIFICATION AND REPORT PREPARED FOR THE PURPOSE AND IN ACCORDANCE WITH THE

THE AREA MARKED THUS /// ON THIS PLAN INDICATES FILL DEEPER THAN 300mm PLACED ON

CONFIRMED BY A PROPER GEOTECHNICAL INVESTIGATION

THE EXTENT OF AND DEPTH OF FILL MUST BE

APPROPRIATE BUILDING REGULATIONS.

BY AN EXPERIENCED PRACTITIONER.

PRELIMINARY

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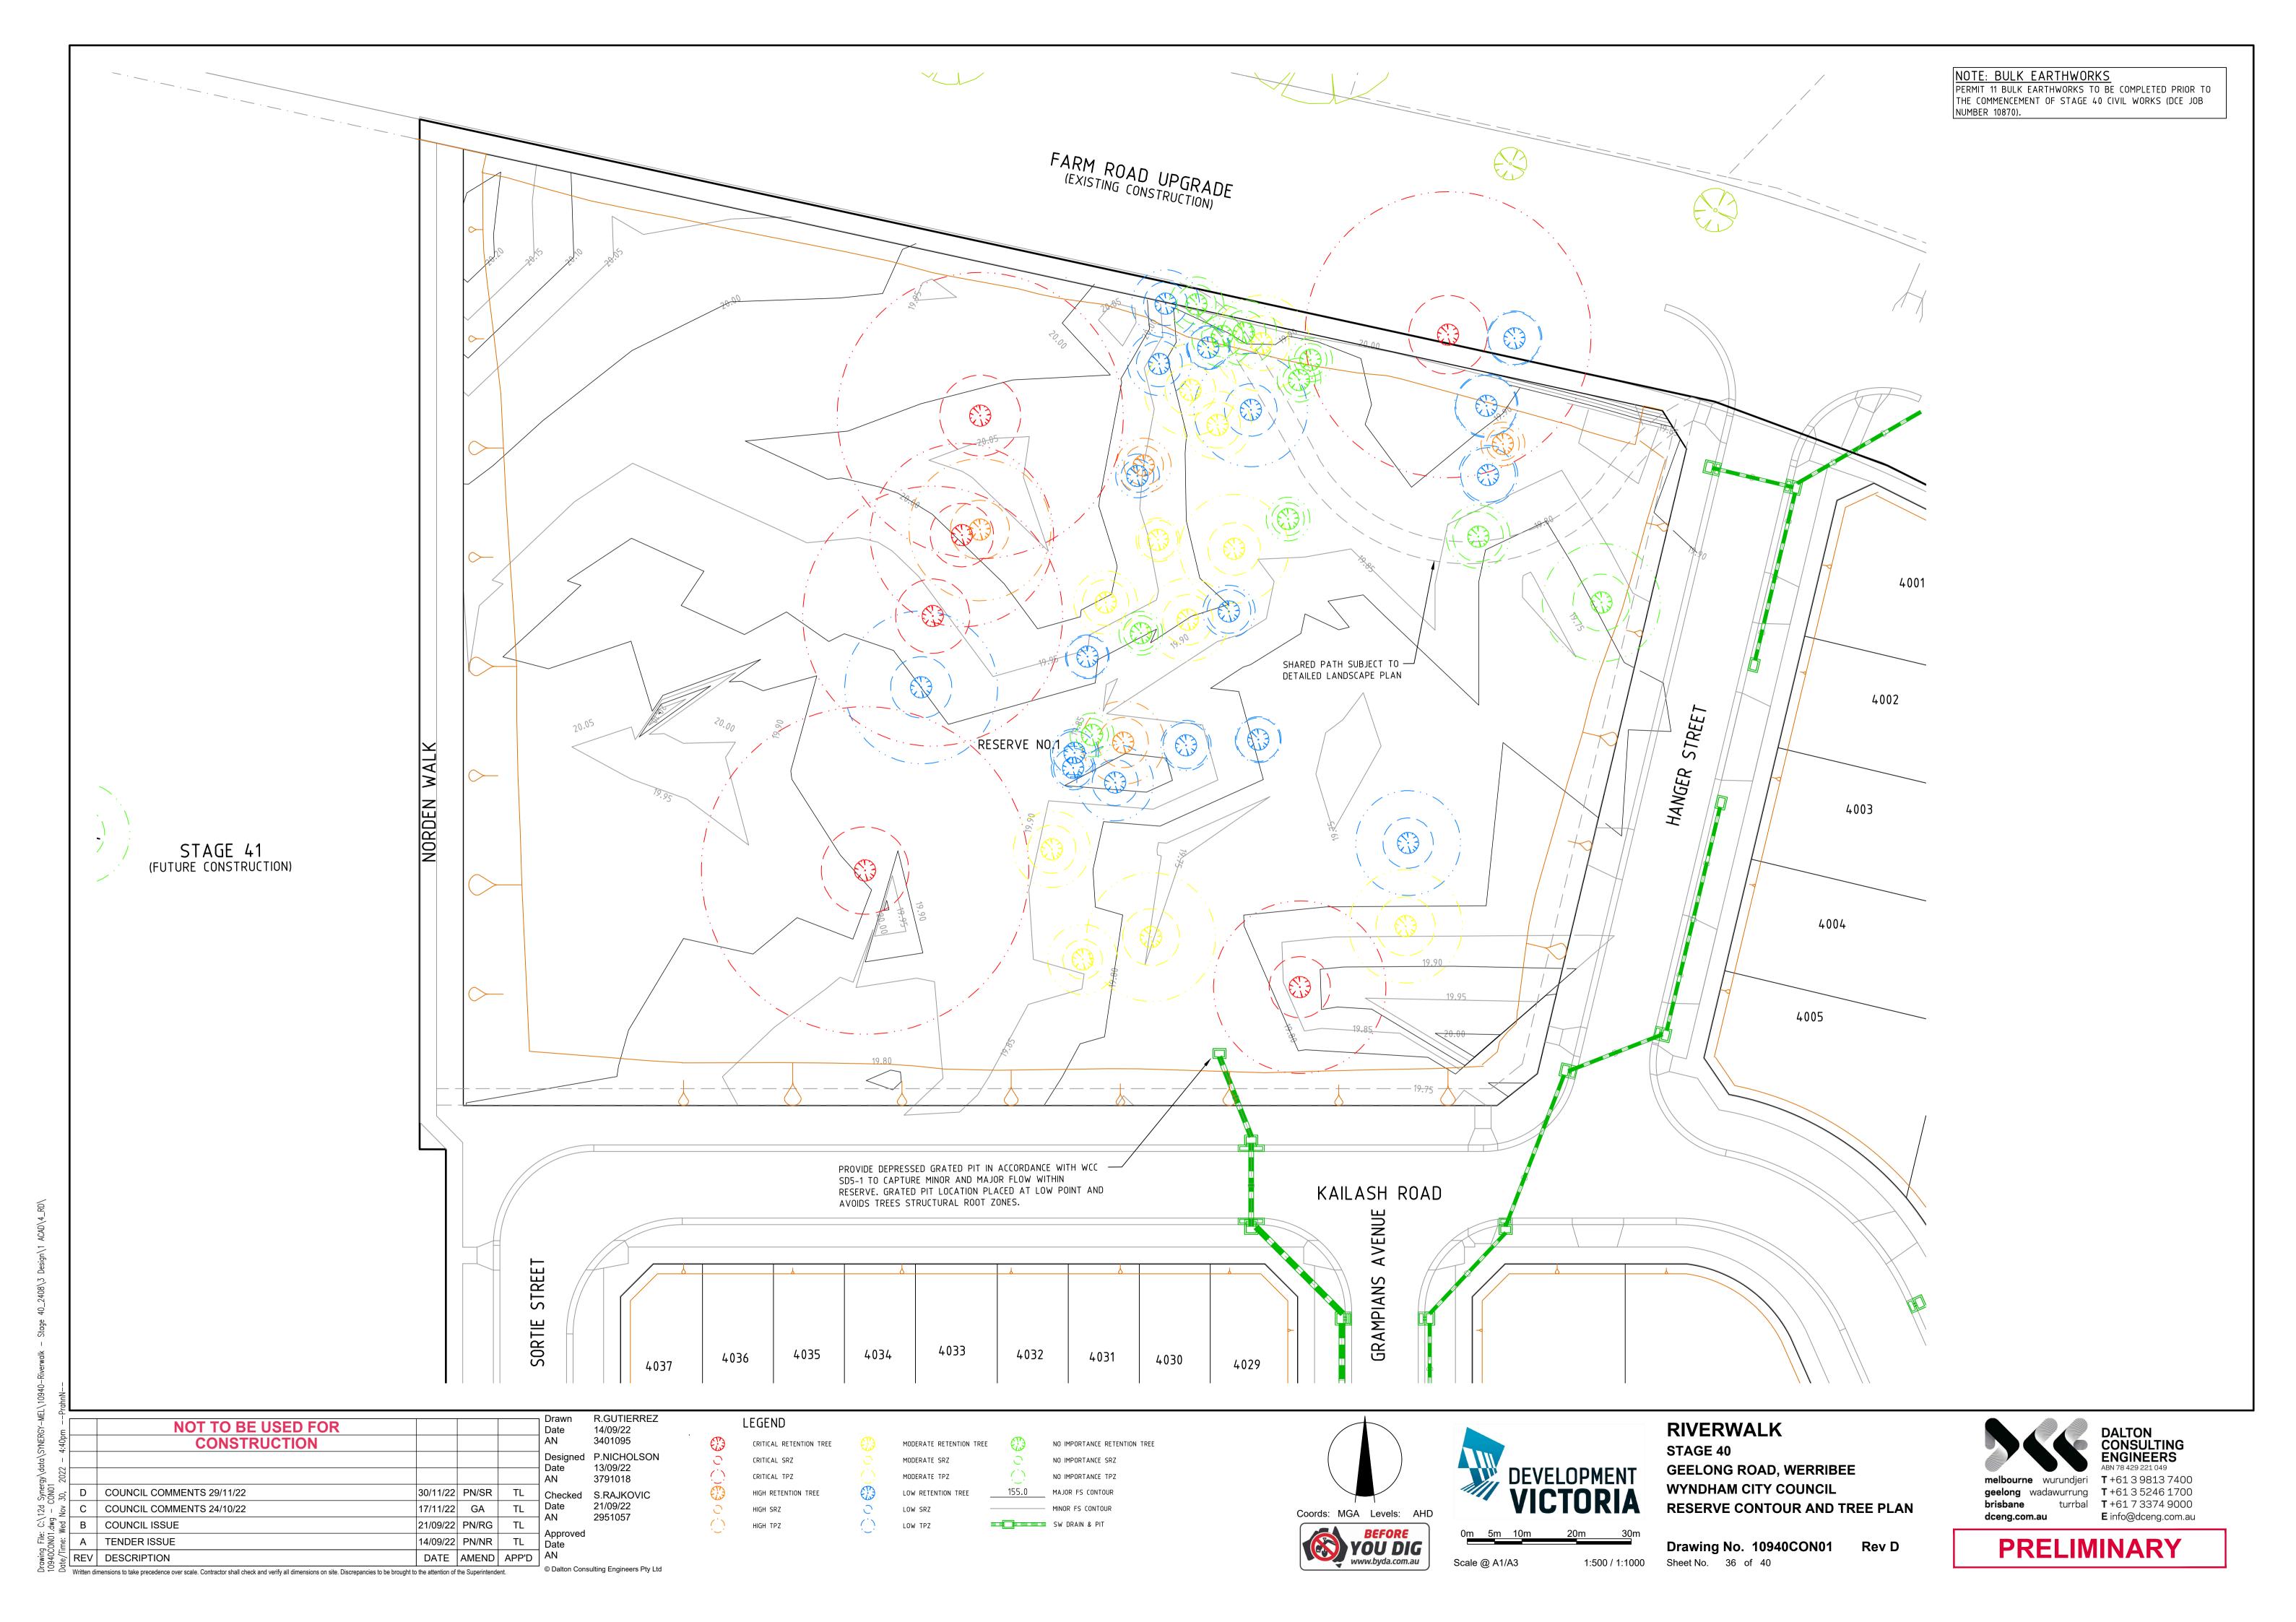
NOT TO BE USED FOR 14/09/22 CONSTRUCTION 3401095 Designed P.NICHOLSON Date 13/09/22 3791018 D COUNCIL COMMENTS 29/11/22 |30/11/22| PN/SR | TL Checked S.RAJKOVIC Date 21/09/22 C COUNCIL COMMENTS 24/10/22 17/11/22 GA 2951057 B | COUNCIL ISSUE 21/09/22 PN/RG 14/09/22 PN/NR TL Date A TENDER ISSUE DATE AMEND APP'D AN REV DESCRIPTION


Written dimensions to take precedence over scale. Contractor shall check and verify all dimensions on site. Discrepancies to be brought to the attention of the Superintendent.

LEGEND ES20.06 EXISTING SURFACE LEVEL FS21.65 FINISHED SURFACE LEVEL T0B21.65 TOP OF BATTER REGRADE LOT (MIN 1:150) LIMIT OF WORKS FILLING OVER 300mm - BATTER — — — — ALLOTMENT PAD BOUNDARY

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Coords: MGA Levels: AHD www.byda.com.au



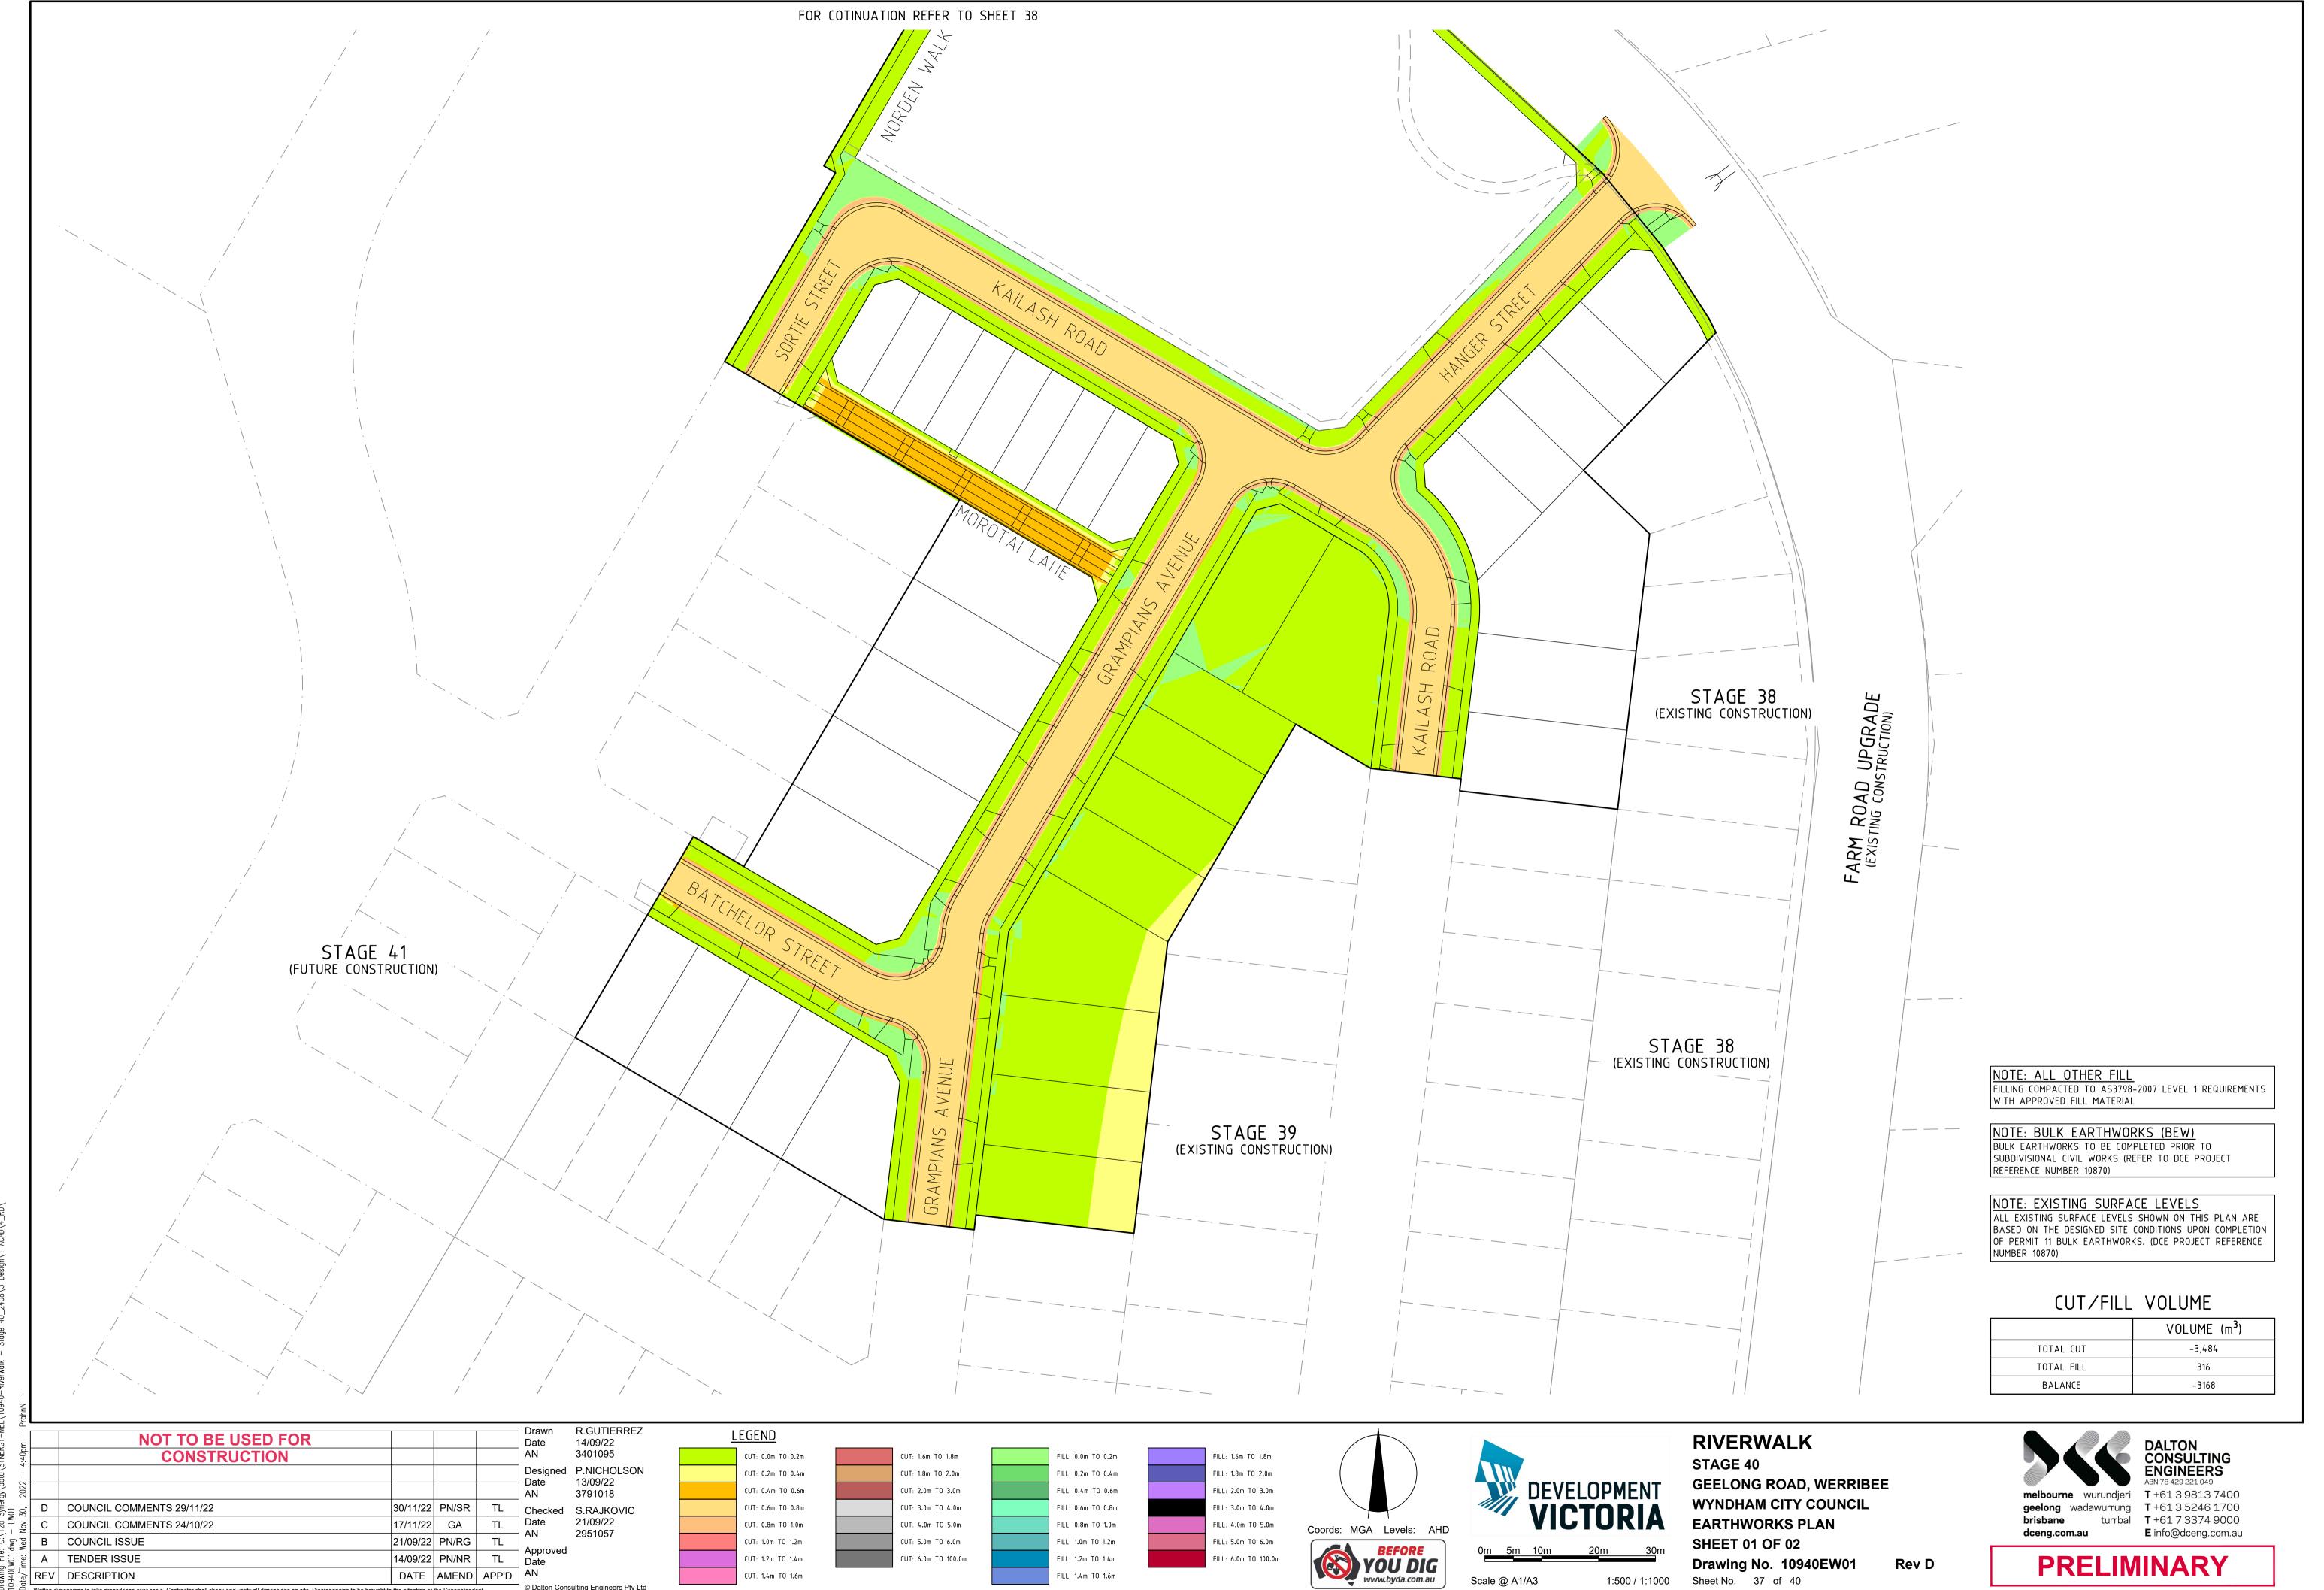


1:500 / 1:1000

Scale @ A1/A3

Sheet No. 37 of 40

Written dimensions to take precedence over scale. Contractor shall check and verify all dimensions on site. Discrepancies to be brought to the attention of the Superintendent.

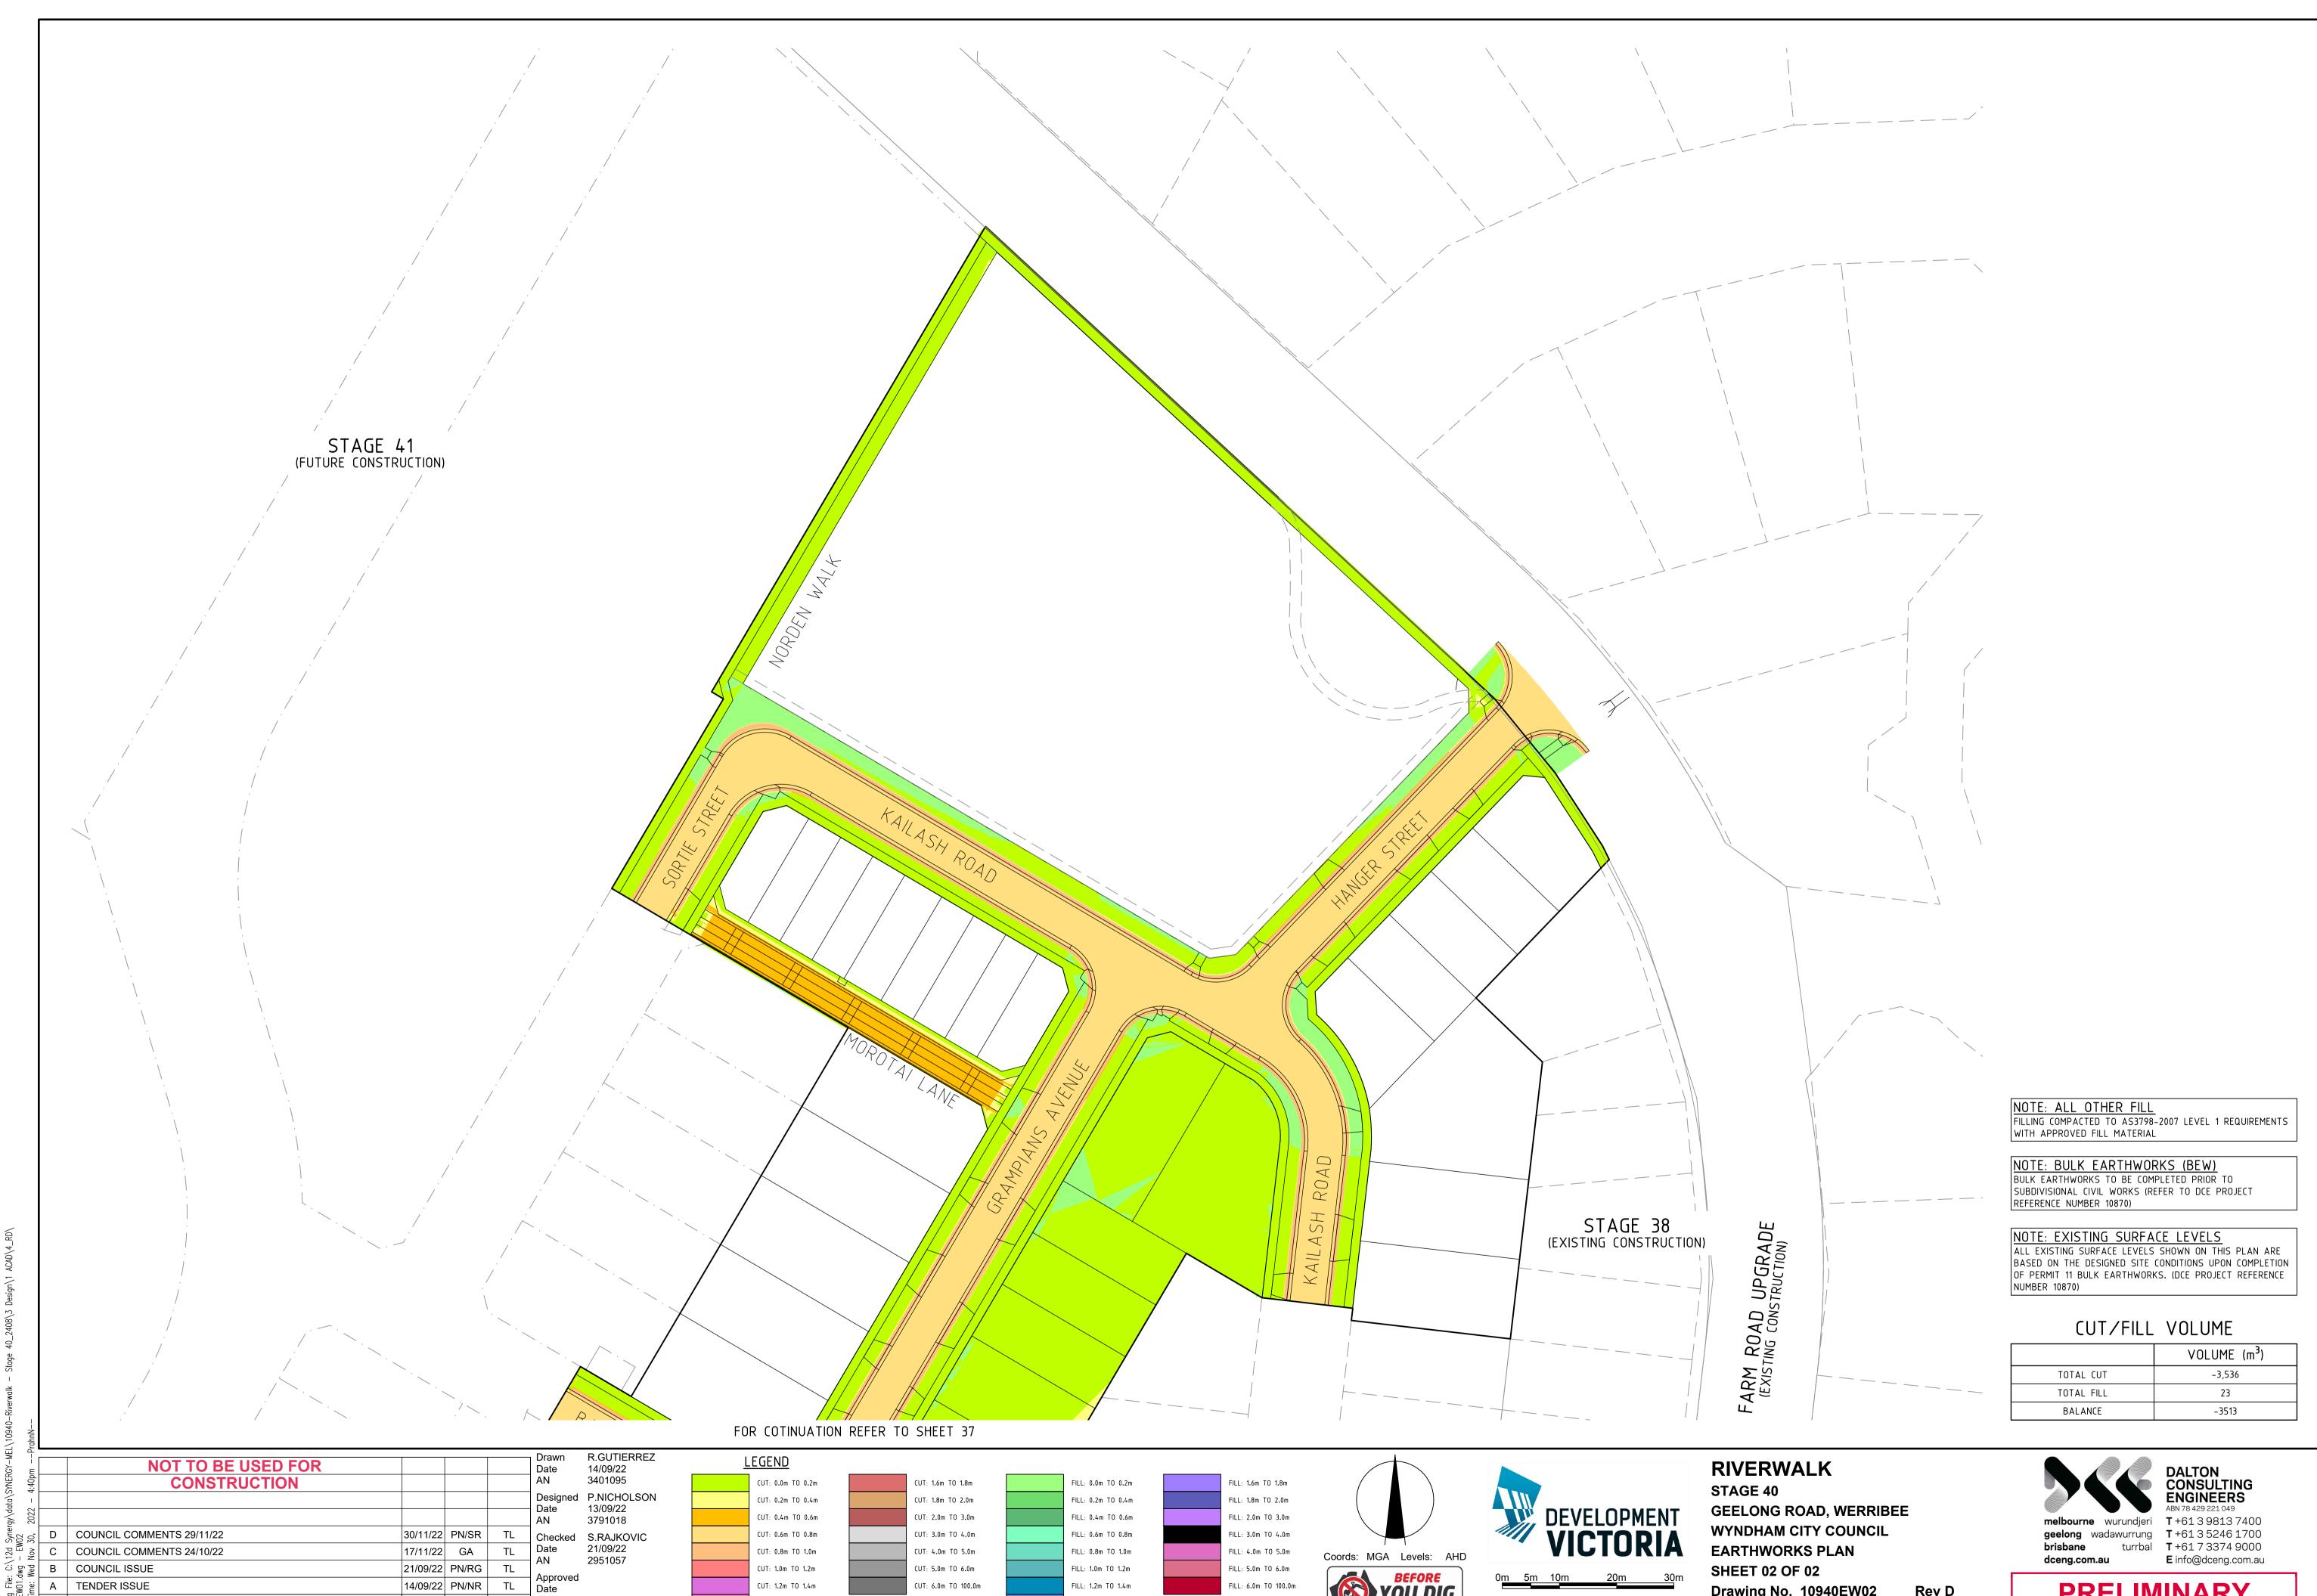

FILL: 6.0m TO 100.0m

Scale @ A1/A3

1:500 / 1:1000

CUT: 6.0m TO 100.0m

FILL: 1.2m TO 1.4m

FILL: 1.4m TO 1.6m

CUT: 1.2m TO 1.4m

CUT: 1.4m TO 1.6m

DATE AMEND APP'D AN

A TENDER ISSUE

Written dimensions to take precedence over scale. Contractor shall check and verify all dimensions on site. Discrepancies to be brought to the attention of the Superintendent.


REV DESCRIPTION

PRELIMINARY

Drawing No. 10940EW02

Sheet No. 38 of 40

Rev D

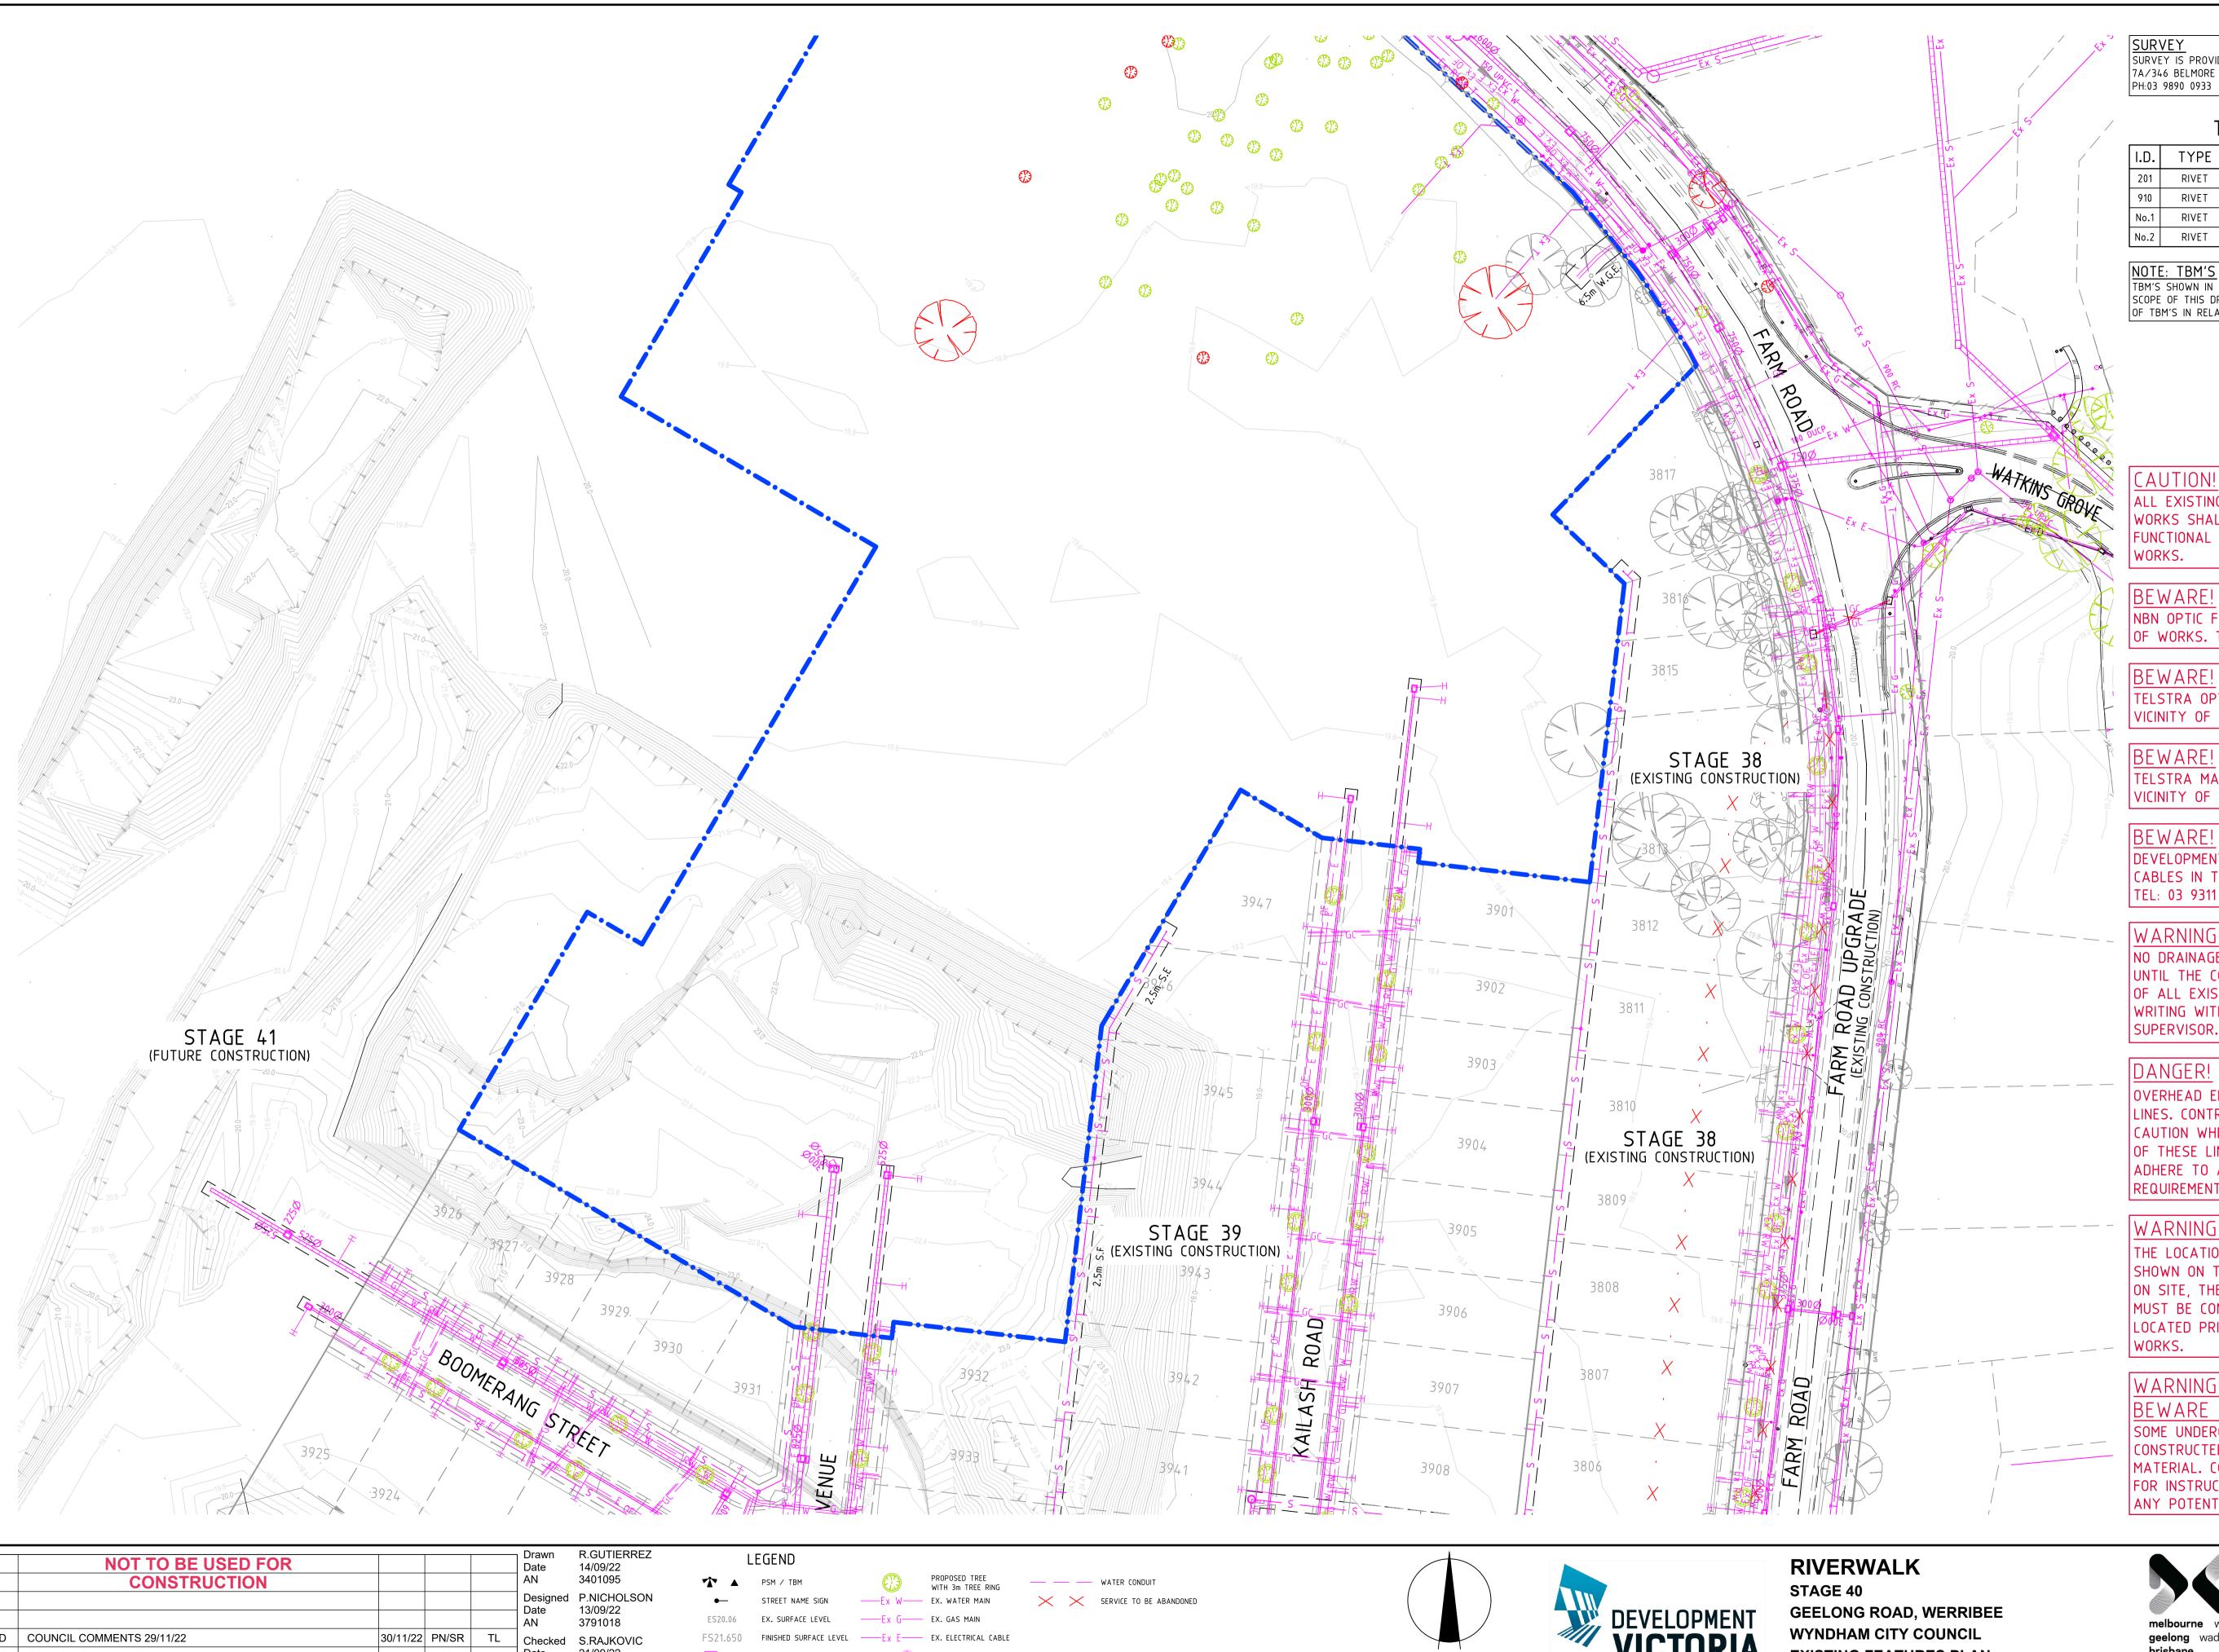

SURVEY
SURVEY IS PROVIDED BY CRA SURVEY PTY LTD 7A/346 BELMORE ROAD, BALWYN VIC 3103 PH:03 9890 0933

TBM SCHEDULE

| I.D. | TYPE | EASTING | NORTHING | LEVEL |
|------|-------|------------|-------------|-------|
| 201 | RIVET | 293313.889 | 5801608.486 | 20.32 |
| 910 | RIVET | 293299.340 | 5801399.356 | 20.35 |
| No.1 | RIVET | 293130.10 | 5801386.10 | 19.52 |
| No.2 | RIVET | 293032.03 | 5801403.63 | 19.69 |

NOTE: TBM'S
TBM'S SHOWN IN THE TABLE ABOVE ARE OUTSIDE OF THE
SCOPE OF THIS DRAWING. REFER TO 10940SP01 FOR LOCATION
OF TBM'S IN RELATION TO STAGE 40 WORKS.

CAUTION!

ALL EXISTING SERVICES IN THE VICINITY OF WORKS SHALL BE PROTECTED AND KEPT IN FUNCTIONAL STATE AT ALL TIMES DURING

NBN OPTIC FIBRE CABLES IN THE VICINITY OF WORKS. TEL: 1800 687 626.

TELSTRA OPTIC FIBRE CABLES IN THE VICINITY OF WORKS. TEL: 9253 8263.

BEWARE!

TELSTRA MAJOR CABLES ARE IN THE VICINITY OF WORKS.

DEVELOPMENT VICTORIA FITH OPTIC FIBRE CABLES IN THE VICINITY OF WORKS. TEL: 03 9311 4575.

WARNING!

NO DRAINAGE WORKS SHALL COMMENCE UNTIL THE CONTRACTOR CONFIRMS THE I.L. OF ALL EXISTING DRAINS, AND CONFIRMS IN WRITING WITH THE ENGINEERING SUPERVISOR.

DANGER!

OVERHEAD ELECTRICITY TRANSMISSION LINES. CONTRACTOR TO EXERCISE EXTREME CAUTION WHEN OPERATING IN THE VICINITY OF THESE LINES. THE CONTRACTOR MUST ADHERE TO ALL "NO GO ZONE" REQUIREMENTS OF THE POWER AUTHORITY.

WARNING!

THE LOCATION OF EXISTING SERVICES SHOWN ON THESE PLANS MUST BE PROVEN ON SITE, THE APPROPRIATE AUTHORITY MUST BE CONTACTED AND THE SERVICES LOCATED PRIOR TO COMMENCEMENT OF ANY

WARNING!


BEWARE OF ASBESTOS! SOME UNDERGROUND SERVICES MAY BE CONSTRUCTED FROM ASBESTOS CONTAINING MATERIAL. CONTACT THE SUPERINTENDENT FOR INSTRUCTIONS ON HOW TO MANAGE ANY POTENTIAL ASBESTOS HAZARD.


| | NOT TO BE USED FOR | | | | Dr. Da |
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| | CONSTRUCTION | | | | A١ |
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| D | COUNCIL COMMENTS 29/11/22 | 30/11/22 | PN/SR | TL | Cł |
| С | COUNCIL COMMENTS 24/10/22 | 17/11/22 | GA | TL | Da |
| В | COUNCIL ISSUE | 21/09/22 | PN/RG | TL | AI A |
| Α | TENDER ISSUE | 14/09/22 | PN/NR | TL | Ap Da |
| A REV | DESCRIPTION | DATE | AMEND | APP'D | A١ |

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| Drawn Date AN | R.GUTIERREZ 14/09/22 3401095 |
|----------------------------|------------------------------------|
| Designed Date AN | P.NICHOLSON 13/09/22 3791018 |
| Checked Date AN | S.RAJKOVIC 21/09/22 2951057 |
| Approved Date AN | |

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Scale @ A1/A3

1:500 / 1:1000

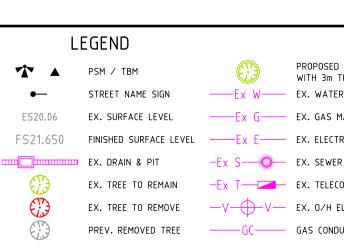EXISTING FEATURES PLAN SHEET 01 OF 02 Drawing No. 10940EF01

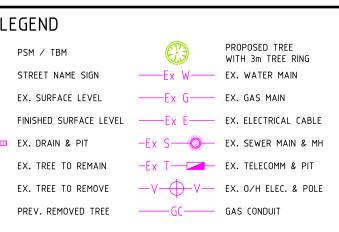Sheet No. 39 of 40




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SURVEY
SURVEY IS PROVIDED BY CRA SURVEY PTY LTD 7A/346 BELMORE ROAD, BALWYN VIC 3103 PH:03 9890 0933

TBM SCHEDULE

| I.D. | TYPE | EASTING | NORTHING | LEVEL |
|------|-------|------------|-------------|-------|
| 201 | RIVET | 293313.889 | 5801608.486 | 20.32 |
| 910 | RIVET | 293299.340 | 5801399.356 | 20.35 |
| No.1 | RIVET | 293130.10 | 5801386.10 | 19.52 |
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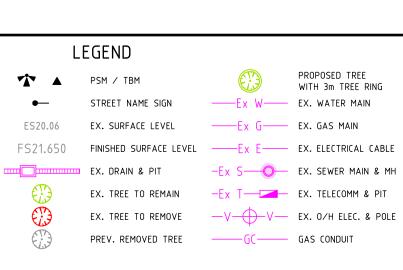
WARNING!


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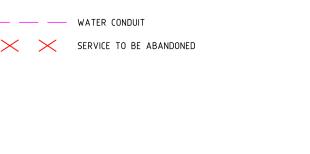
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| | Drawn Date AN | R.GUTIERREZ 14/09/22 3401095 |
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| | Checked Date AN | S.RAJKOVIC 21/09/22 2951057 |
| | Approved Date AN | |
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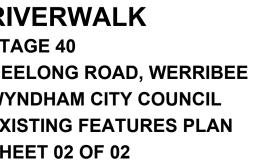


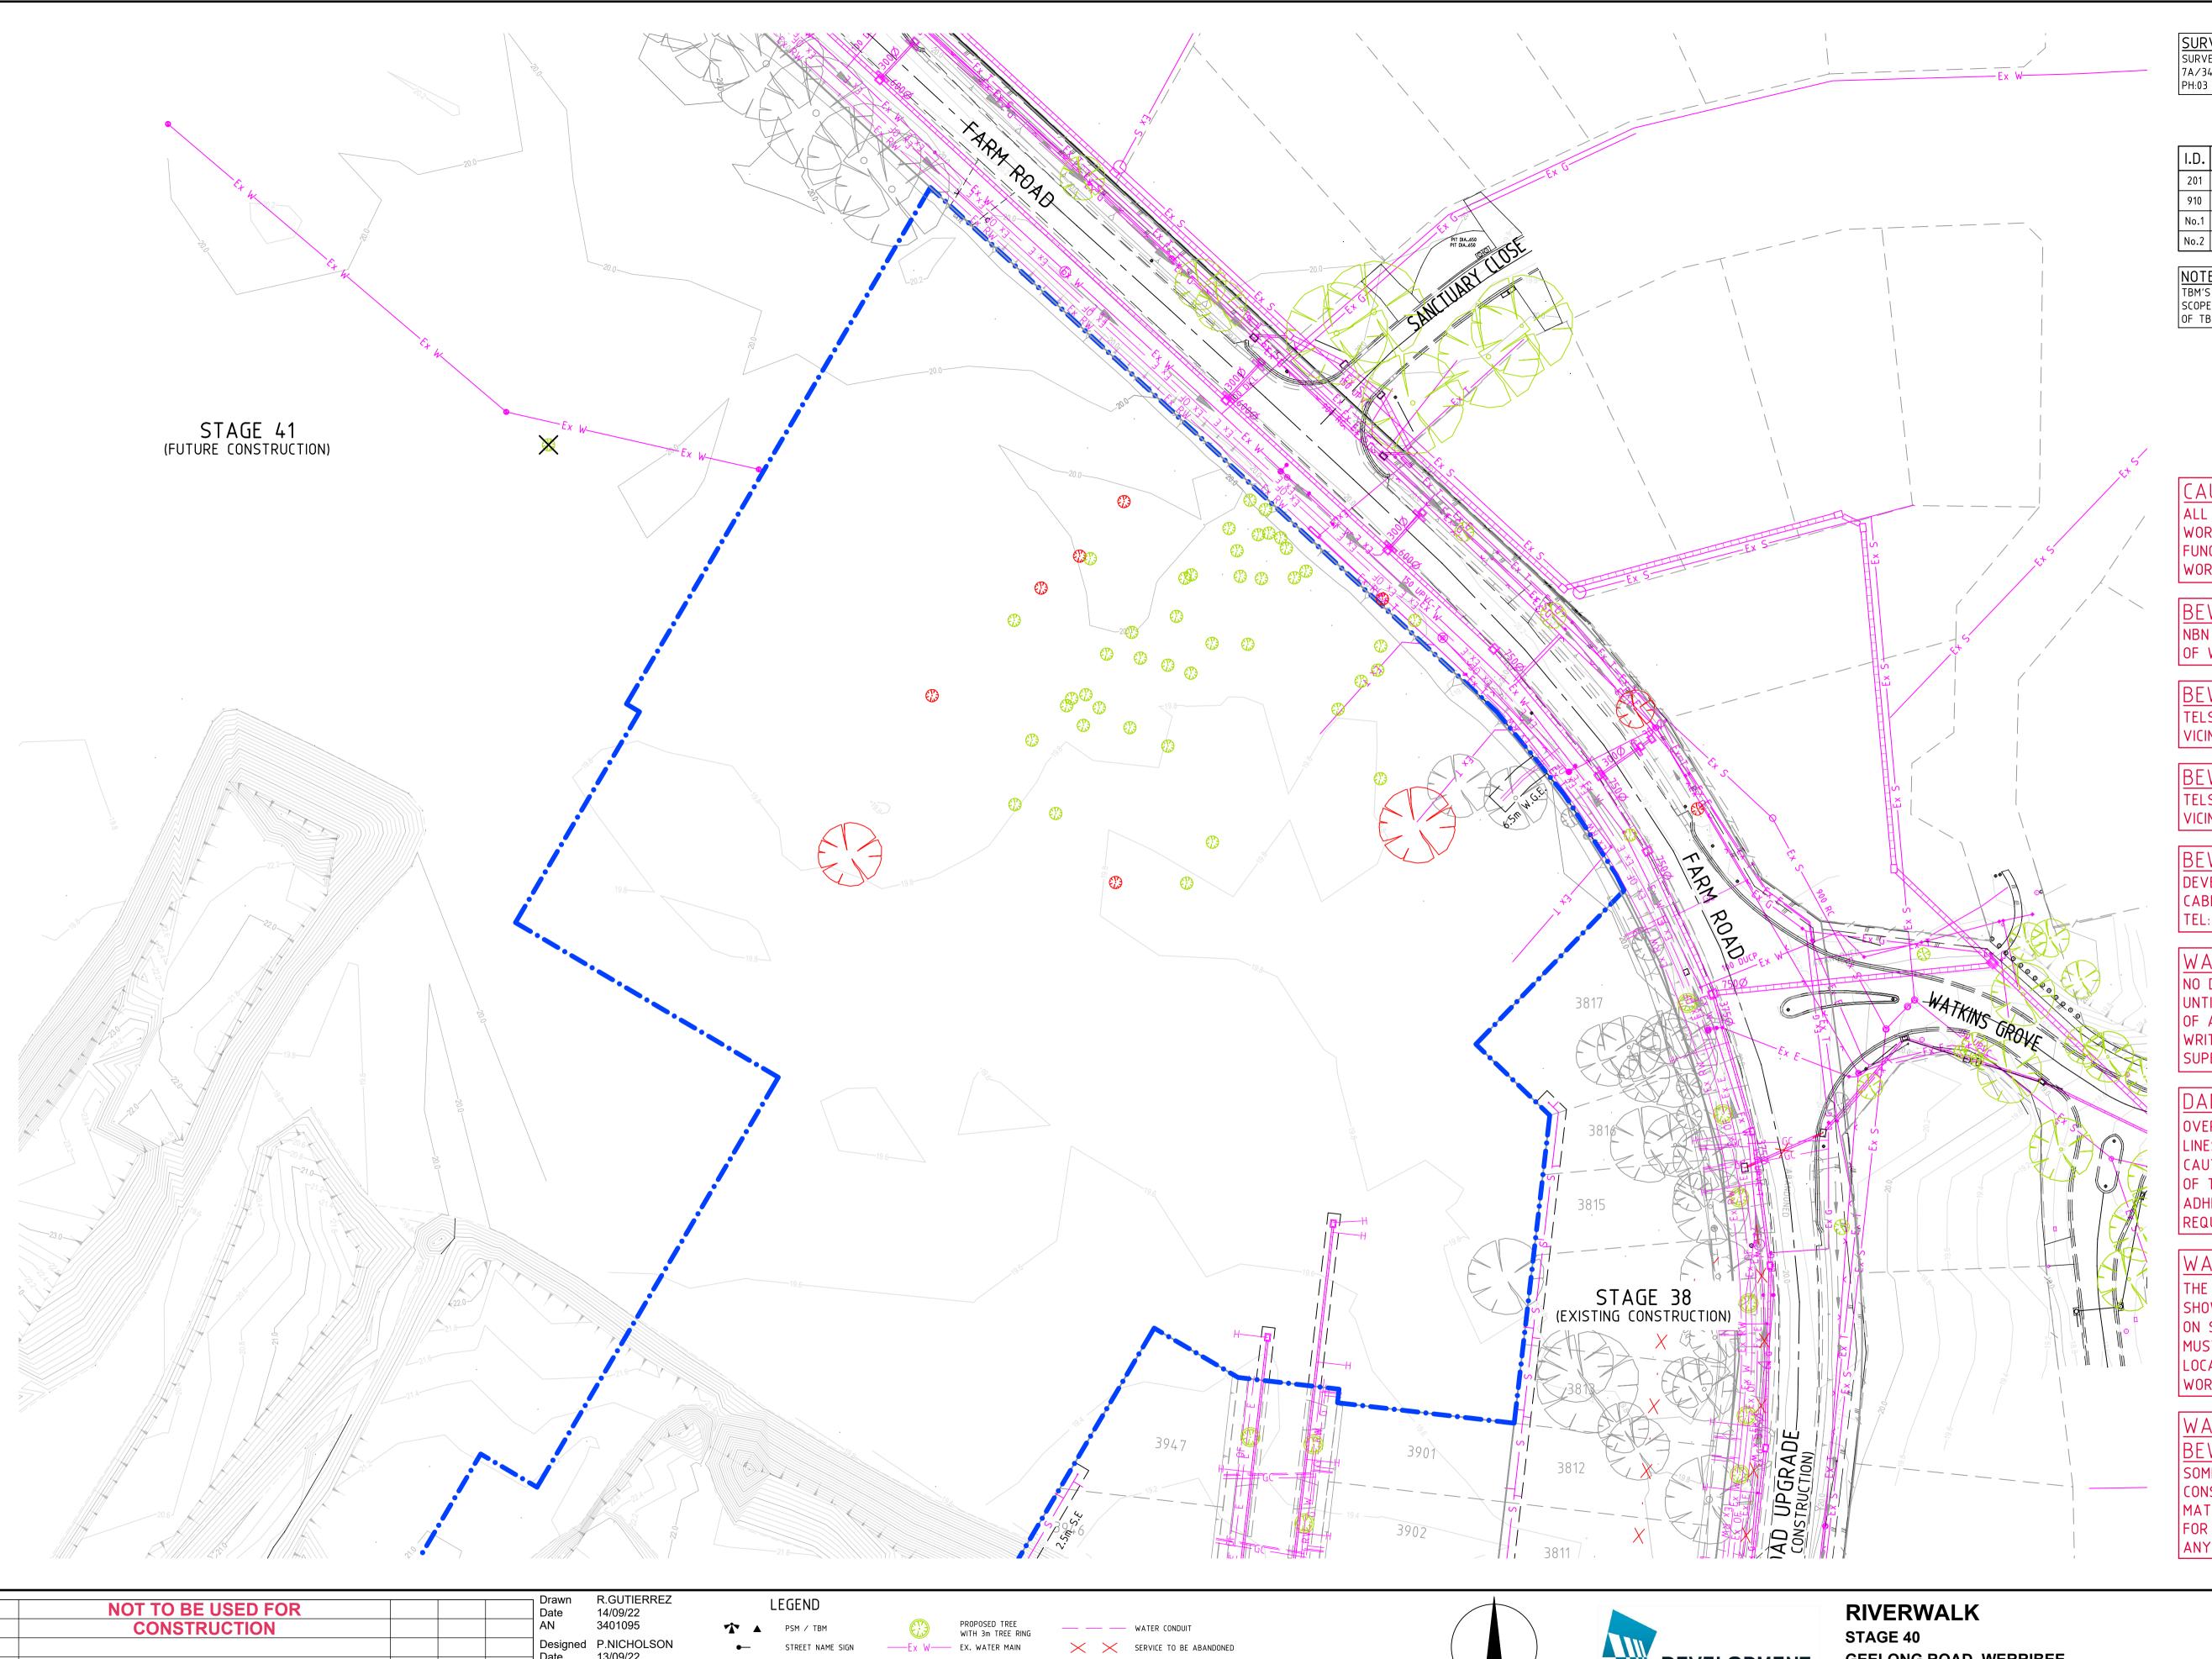

Scale @ A1/A3

GEELONG ROAD, WERRIBEE WYNDHAM CITY COUNCIL **EXISTING FEATURES PLAN SHEET 02 OF 02** Drawing No. 10940EF02

Sheet No. 40 of 40

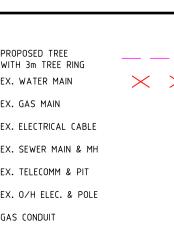

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